Renovations and Additions for the

Ryan Residence

32 Hidden Dr.

Rocky River, OH 44116

Owner: Kevin and Carol 32 Hidden Valley Dr. Rocky River, OH 44116

XXX-XXX-XXXX

Architect: Dimit Architects, LLC 14725 Detroit Avenue Suite # 210 Lakewood, OH 44107 216-221-9021

ABBREVIATIONS



VICINITY MAP

	Issue:	Date:	Ву:
L	PRICING SET	09/11/23	SMD
44	PRICING SET-VE REVISION	10/26/23	SMD
9	REVIEW SET	11/29/23	SMD

architecture + interiors + urban desig

14725 Detroit Avenue • Suite 210

Lakewood, Ohio 44107

DRAWING LEGEND ROOM NAME ROOM NUMBER DOOR NUMBER WINDOW TAG WALL TYPE - SECTION NUMBER - SHEET WHERE ELEVATION LOCATED SHEET ON WHICH DETAIL IS LOCATED WALL SECTION/EXTERIOR ELEVATION -SECTION/DETAIL NUMBER _SHEET ON WHICH DETAIL IS LOCATED POROUS FILL CONCRETE CONCRETE MASONRY UNIT WOOD-ROUGH GYPSUM WALLBOARD RIGID INSULATION BATT INSULATION

INTERIOR DIAMETER EACH FACE ACOUSTIC CEILING **ELEVATION** RIGHT-OF-WAY ROOF DRAIN REINFORCING BARS JUNCTION BOX EQUIPMENT REINFORCEMEN' LAVATORY LINEAL FEET **EXTERIOR** LONG LEG HORIZONTAI ELECTRICAL WATER SOLID CORE LONG LEG VERTICAL SQUARE FEET SQUARE MAINTENANCE STAINLESS STEEL SOUND TRANSMISSION FIRE HYDRANT CENTER-TO-CENTER MECHANICAL **CONTROL JOINT** STRUCTURAL SUPPL SUSP SUPPLEMENTARY SUSPENDED FACTORY MUTUAL MASONRY OPENING FIRE RATED FIRE RETARDANT TOP OF BEAM MASONRY UNIT TONGUE-AND-GROOVE NOT APPLICABLE CONFERENCE THRESHOLD CONSTRUCTION TOP OF JOIST TOP OF MASONRY TOP OF SLAB OUTSIDE DIAMETER GENERAL CONTRACTOR **OPPOSITE** DOUBLE VINYL COMPOSITION TILE DRAIN DEMISING VERT VERTICAL PARTITION DRINKING FOUNTAIN HEIGHT, HIGH VEST VESTIBULE PLBG PLUMBING HANDICAPPED VINYL TILE PLATE DIMENSION HAND DRYER PLASTER HARDWARE WATER CLOSET PAINT (PAINTED FINISHED) DOWNSPOUT HOLLOW METAL WOOD PTR DAMPPROOFING HORZ. HORIZONTAL WITHOUT PROJ PROJECT DOOR HOUR WASTE RECEPTACLE PRESSURE TREATED DETAIL HVAC HEATING VENTILATION PLYWD PLYWOOD WELDED WIRE FABRIC DWG DRAWING # AIR CONDITIONING

ASTM A36

ASTM A992

ASTM A500

ASTM A53


RISK CATEGORY: WIND EXPOSURE: COEFFICIENT:

CODE & ZONING DATA ORC 2013 CODE INFORMATION PROJECT ADDRESS 32 HIDDEN VALLEY DR. ROCKY RIVER, OH 44116 PROPERTY OWNERS: KEVIN & CAROL RYAN EXISTING ZONING DISTRICT: R-3 (SINGLE-FAMILY ATTACHED) RESIDENCE SURFACE AREA 1,049 S.F. 1,222 S.F. EXISTING LOWER LEVEL EXISTING FIRST FLOOR 1,608 S.F. (INCLUDING GARAGE) EXISTING SECOND FLOOR 1,060 S.F. 1,088 S.F. 290 S.F. 261 S.F FIRST FLOOR ADDITION 4,294 S.F 4,006 S.F. STRUCTURAL DESIGN CRITERIA ROOF LIVE LOAD

ROOF SNOW LOAD DATA: GROUND SNOW LOAD FLAT ROOF SNOW LOAD MIN. ROOF SNOW LOAD DESIGN WIND SPEED:

APPLICABLE INTERNAL PRESSURE

V(u|t)=115 MPH, V(asd)=89 MPH $GCp_1 = \pm 0.18$

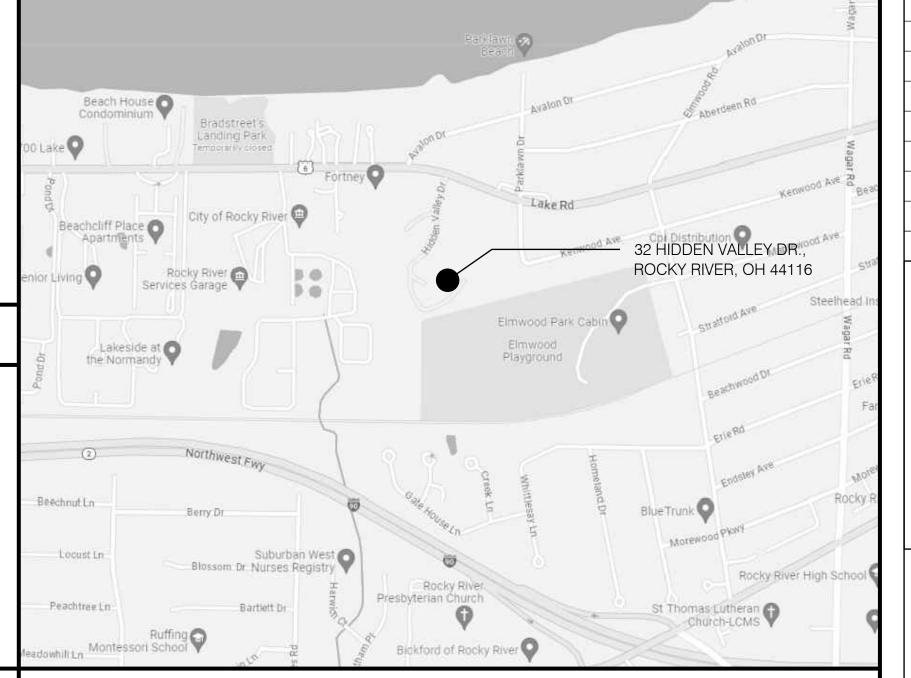

PROJECT SUMMARY

THIS PROJECT IS AN EXISTING SINGLE-FAMILY TOWNHOUSE IN THE CITY OF ROCKY RIVER, OHIO, LOCATED AT 32 HIDDEN VALLEY DR. ROCKY RIVER, OH 44 I I 6. THE SCOPE CONSISTS OF A WOOD FRAMED ADDITION CONNECTING THE FIRST FLOOR TO A DETACHED GARAGE, AS WELL AS, SELECT AREAS OF RE-FINISHING EXTERIOR MATERIALS, INCLUDING NEW SIDING, ROOFING AND

AR-8

AR-9

INTERIOR RENDERING

INTERIOR RENDERING

INTERIOR RENDERING

INTERIOR RENDERING

ALL NEW FOOTINGS SHALL BEAR ON UNDISTURBED, FIRM NATURAL SOIL CAPABLE OF SUPPORTING AN ASSUMED DESIGN BEARING PRESSURE OF 2.0

GENERAL STRUCTURAL NOTES

CAST-IN-PLACE CONCRETE WORK SHALL CONFORM TO THE LATEST AMERICAN CONCRETE INSTITUTE CODES AND STANDARDS LISTED IN THE SPECIFICATIONS, EXCEPT AS MODIFIED THEREIN OR ON THE DRAWINGS.

ULTIMATE COMPRESSIVE STRENGTH OF CONCRETE IN 28 DAYS:

3,000 PSI COLUMN AND WALL SPREAD FOOTINGS: 3,500 PSI INTERIOR SLAB: ALL OTHER CONCRETE: 4,000 PSI

REINFORCING BARS: ASTM 615, GRADE 60

WELDED WIRE FABRIC: ASTM A I 85, FLAT SHEET. ROLLED WWF SHALL NOT BE PERMITTED. MASONRY CONSTRUCTION SHALL CONFORM TO THE LATEST EDITIONS OF THE REFERENCES AND STANDARDS LISTED BELOW, EXCEPT MODIFIED HEREIN, IN ADDITION TO ALL OTHER REQUIREMENTS OF THE CONTRACT DOCUMENTS AND STANDARD PRACTICES. A. BUILDING CODE REQUIREMENTS FOR MASONRY STRUCTURES (ACI 530/ASCE 5/TMS 402) B. SPECIFICATION FOR MASONRY STRUCTURES (ACI 530.1/ ASCE 6/ TMS 602)

PRISM COMPRESSIVE STRENGTH (fm) SHALL BE 1900 PSI AT AN AGE OF 28 DAYS. AS DETERMINED BY THE UNIT STRENGTH METHOD OF ACI 530.1. THE UNITS SHALL BE MANUFACTURED SO THE CORES AND WEBS LINE UP WHEN LAID IN A RUNNING BOND. A. UNITS SHALL BE MEDIUM WEIGHT UNITS WITH A DRY NET WEIGHT OF NOT MORE THAN

HOLLOW LOAD - BEARING MASONRY UNITS SHALL CONFORM TO ASTM C90. THE MINIMUM

DETAIL, FABRICATE AND ERECT STRUCTURAL STEEL IN ACCORDANCE WITH THE LATEST AISC AND OTHER RELATED CODES AND STANDARDS.

SHAPES (EXCEPT WIDE FLANGE), PLATES, BARS AND RODS: GRADE 50, WIDE FLANGE SHAPES: GRADE B, STEEL TUBING: TYPE E OR S, GRADE B, STEEL PIPE:

BOLTS: 3" DIAMETER, ASTM F3 | 25, GRADE A325, TYPE |, FOR ALL BEAM AND COLUMN CONNECTIONS, DESIGNED AS BEARING TYPE WITH TREADS INCLUDED IN THE SHEAR PLANE, UNLESS NOTED OTHERWISE.

ANCHOR RODS SHALL BE ASTM F1554, GRADE 36, UNLESS NOTED OTHERWISE.

CONNECTIONS: WELD OR BOLT CONNECTIONS, AS INDICATED.

WELDING SHALL CONFORM WITH AWS E-70 ELECTRODES, MIN.

GENERAL NOTES

WRITTEN DIMENSIONS SHALL HOLD PREFERENCE OVER SCALED DIMENSIONS. DO NOT SCALE DRAWINGS. GENERAL CONTRACTOR AND EACH SUBCONTRACTOR SHALL VISIT SITE TO VERIFY ALL EXISTING CONDITIONS PRIOR TO SUBMITTING BIDS. REPORT ANY DISCREPANCIES DURING BIDDING PROCESS AND BEFORE START OF CONSTRUCTION. EXTRAS WILL NOT BE ALLOWED FOR UN-VERIFIED EXISTING JOB

CONDITIONS ALL WORK SHALL BE PERFORMED ACCORDING TO STATE AND LOCAL BUILDING CODE REQUIREMENTS. GENERAL CONTRACTOR SHALL OBTAIN AND PAY FOR ALL REQUIRED PERMITS AND

GENERAL CONTRACTOR AND EACH SUBCONTRACTOR SHALL: COMPLY WITH ALL LOCAL AND STATE CODES AND ORDINANCES GOVERNING THE WORK.

ALL WORK SHALL BE PERFORMED IN A FIRST CLASS WORKMANLIKE MANNER AND IN NO WAY SHALL WEAKEN THE STRUCTURAL STRENGTH OR FIREPROOFING OF THE BUILDING. ALL DAMAGE SHALL BE IMMEDIATELY REPAIRED AND AT NO COST TO THE OWNER.

ALL WORK SHALL BE GUARANTEED FOR ONE (1) YEAR AFTER SUBSTANTIAL COMPLETION OF ALL WORK.

REMAIN RESPONSIBLE FOR COMPLAINCE WITH THE PROVISIONS OF THE OCCUPATIONAL SAFTELY AND HEALTH ACT, LATEST PROVIDE THE OWNER WITH A CERTIFICATE OF INSURANCE FOR

ALL LIABILITIES. CONTRACTOR SHALL INCLUDE BUILDER'S RISK

COVERAGE IN HIS CERTIFICATE. ALL WORK UNDER THIS CONTRACT SHALL BE PERFORMED IN ACCORDANCE WITH THE LATEST EDITION OF THE AIA GENERAL CONDITIONS DOCUMENT AND IT SHALL BE CONSIDERED PART OF THESE DOCUMENTS AS MODIFIED BY THE SPECIFIC CONDITIONS AND PROVISIONS INCLUDED IN THE DRAWINGS.

5. A. ALL WINDOWS, GLASS, MIRRORS, FLOORS, AND WALL TILES SHALL BE CLEANED AND WASHED UPON COMPLETION OF THE WORK BY GENERAL CONTRACTOR. THE PREMISES SHALL BE KEPT CLEAN DURING ALL PHASES OF THE

CONSTRUCTION. ALL WORK SHALL BE COORDINATED WITH OTHER TRADES IN ORDER TO AVOID INTERFERENCES, PRESERVE MAXIMUM HEADROOM, AND AVOID OMISSIONS. EACH SUBCONTRACTOR SHALL

INCLUDE ALL MISCELLANEOUS ITEMS REQUIRED TO COMPLETE CONTRACTED WORK, INCLUDING RIGGING OF MATERIALS AND EQUIPMENT, ALL HANGERS, SUPPORTS, ANCHORS, SUSPENSION MEANS, CONDUIT, WIRE, FITTINGS, AND/ OR SLEEVES.

7. ALL MATERIALS TO BE INSTALLED SHALL BE NEW AND BEAR U.L. LABELS WHERE REQUIRED AND MEET APPROPRIATE N.E.M.A STANDARDS. 8. ALL NEW GYPSUM BOARD CEILING AND WALL CONSTRUCTION SHALL BE ADEQUATELY BRACED AS PER MANUFACTURERS RECOMMENDATIONS. USE SUFFICIENT STUDS AND CHANNELS AND CONFORM TO INDUSTRY

STANDARDS 9. ALL FIRE STOPPING USED IN WALLS AND ABOVE CEILING TO BE FIRE RETARDANT TREATED. 10. CEILING CONTRACTOR TO PROVIDE ADEQUATE FRAMING FOR CEILING

LIGHTS, CEILING FANS, AND MECHANICAL EQUIPMENT (DIFFUSERS AND/OR ACCESS PANELS) II. ALL ELECTRICAL, PLUMBING, AND MECHANICAL WORK SHALL MEET THE

STANDARDS OF ALL REQUIRED LOCAL AND STATE CODES AND 12. CONTRACTOR TO VERIFY ALL DIMENSIONS, NEW AND EXISTING, IN THE FIELD AND NOTIFY ARCHITECT OF ANY SUBSTANTIAL VARIANCES FROM

THE CONSTRUCTION DOCUMENTS 13. CONTRACTOR SHALL FORWARD TO THE OWNER ALL APPLICABLE WARRANTIES, GUARANTEES, MAINTENANCE MANUALS, ETC. INCLUDING A COPY OF THE CERTIFICATE OF OCCUPANCY PRIOR TO APPLICATION

DRAWING INDEX

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D1-03	SECOND LEVEL EXISTING CONDITIONS / DEMOLITION PLAN	
DI-10	ROOF EXISTING CONDITIONS / DEMOLITION PLAN	
D2-01	DEMOLITION ELEVATIONS	
AI-0I AI-02 AI-03	BASEMENT FLOOR PLAN FIRST LEVEL FLOOR PLAN SECOND LEVEL FLOOR PLAN	
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A2-01	EXTERIOR ELEVATIONS	
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REFLECTED CEILING PLANS

LIGHTING SCHEDULE

INTERIOR ELEVATIONS

EXTERIOR RENDERING INTERIOR RENDERING

INTERIOR RENDERING

INTERIOR RENDERING INTERIOR RENDERING

A5-05

A5-06

AR-2 AR-3

AR-4

Kevin and Carol Ryan Townhouse Renovation INTERIOR RENDERING INTERIOR RENDERING

> 32 Hidden Valley Dr Rocky River, OH, 44116


TITLE SHEET

Date	Project Number
11/29/2023	23-054
, ,	
Drawn by	Drawing Number
JTK/ AND/ KH	
Checked by	$T_{A} \cap A$
SMD/AND	1 1 1 1

SMD/AND





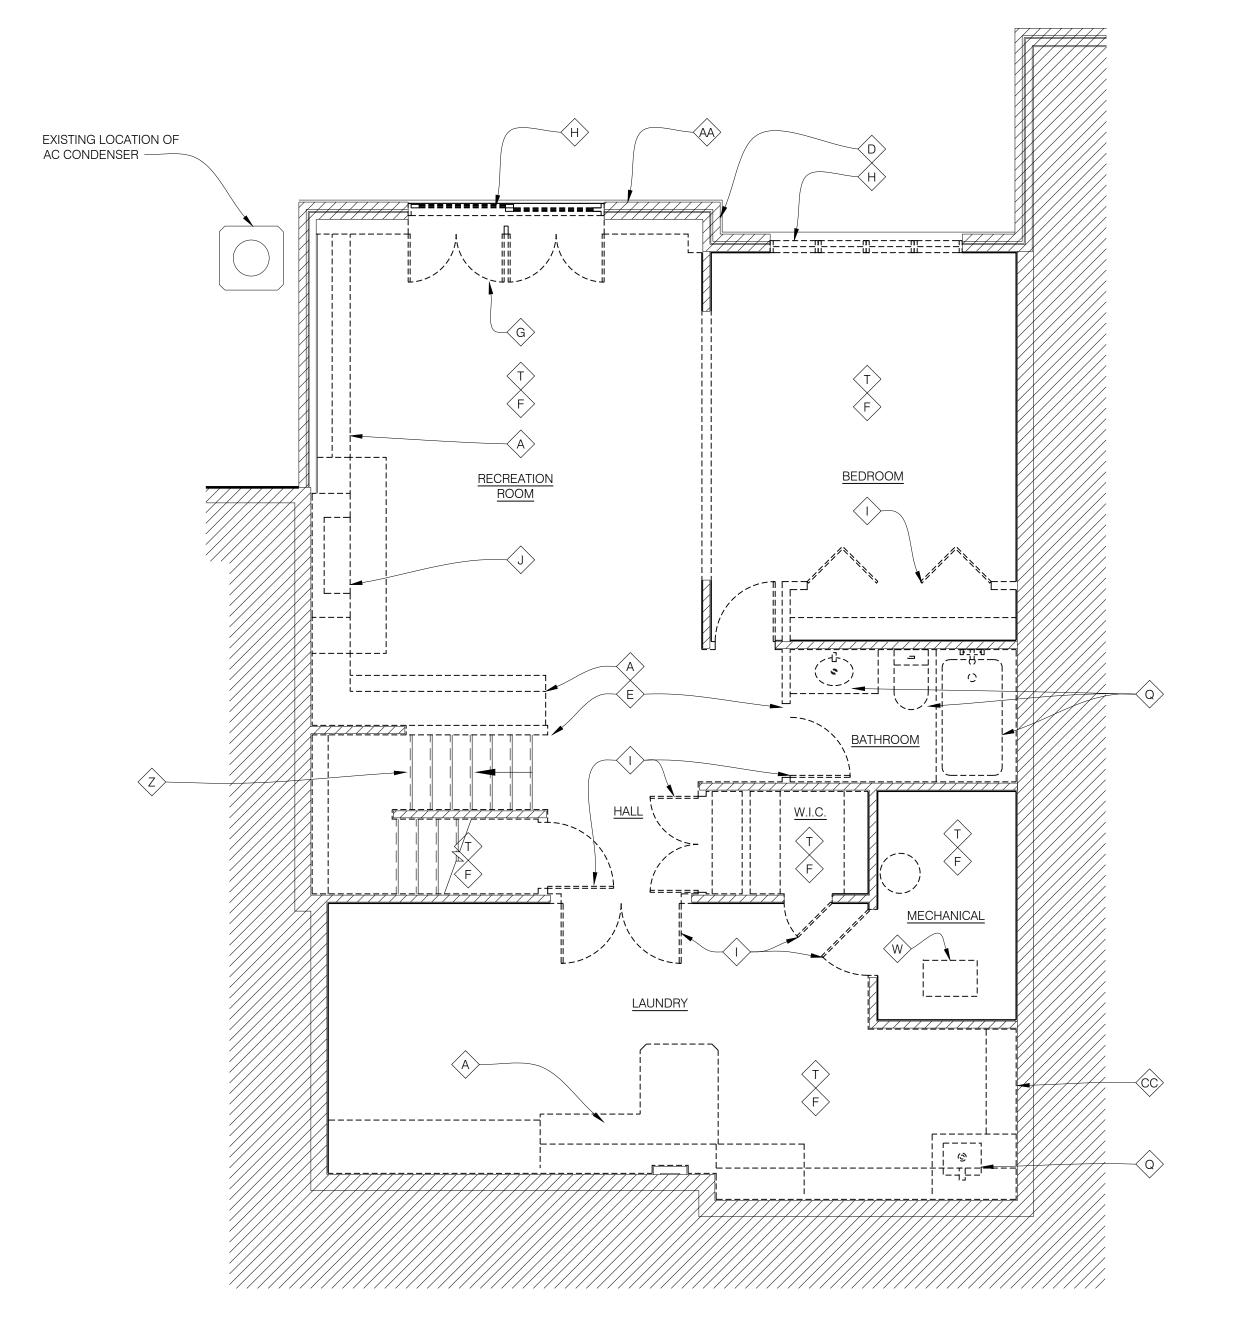

GENERAL DEMOLITION NOTES:

- DEMOLITION SHALL NOT BE LIMITED TO THE ITEMS SPECIFICALLY SHOWN IN THE DRAWINGS. THE INTENT IS TO SHOW THE GENERAL SCOPE OF DEMOLITION REQUIRED TO PREPARE THE SPACES FOR NEW CONSTRUCTION.
- 2. CONTRACTOR TO COMPLY WITH ALL APPLICABLE LOCAL, STATE, AND FEDERAL CODES AS WELL AS ALL OSHA REGULATIONS TO PROTECT SAFETY OF WORKERS, PROPERTY, AND INSURE ENVIRONMENTAL PROTECTION.
- 3. CONTRACTOR TO PREVENT MOVEMENT OR SETTLEMENT OF EXISTING STRUCTURES. CONTRACTOR TO PROVIDE SUFFICIENT TEMPORARY BRACING AND/OR SHORING OF EXISTING STRUCTURE AND ASSUME LIABILITY FOR ANY MOVEMENT, DAMAGE, OR INJURY RESULTING FROM THE DEMOLITION WORK REQUIRED.
- CONTRACTOR TO REMOVE FROM THE SITE AND LEGALLY DISPOSE OF DAILY REFUSE, DEBRIS, RUBBISH, AND OTHER MATERIALS RESULTING FROM DEMOLITION ACTIVITIES. CONTRACTOR SHALL MAINTAIN A REFUSE DUMPSTER ON SITE IF NECESSARY. COORDINATE LOCATION WITH BUILDING OWNER. DEMOLITION SPACE SHALL BE LEFT BROOM-CLEAN AND READY TO RECEIVE NEW CONSTRUCTION.
- 5. REMOVE ALL ELECTRICAL, LIGHTING, TV CABLE, TELEPHONE WIRE AND OUTLET WIRING AND CONDUIT, PLUMBING PIPING, FIXTURES AND FIRE SUPPRESSION, AND MECHANICAL DUCTWORK THAT IS NOT INDICATED TO BE RE-USED IN THE MECHANICAL AND ELECTRICAL DOCUMENTS. COORDINATE UTILITY DISCONNECT WITH UTILITY COMPANY AND BUILDING
- 6. CONTACT ARCHITECT AND/OR OWNER IF DEMOLITION OR REMOVAL OF ANY ITEM NOT SPECIFICALLY IDENTIFIED IS IN QUESTION. ANY RADON TESTING REQUIRED TO BE OWNER PROVIDED.
- 7. CONTRACTORS SHALL VISIT AND INSPECT EXISTING BUILDING SITE AND BECOME FAMILIAR WITH ALL CONDITIONS IN FIELD PRIOR TO SUBMITTING A BID FOR DEMOLITION WORK.
- 8. THE SCOPE OF REPAIRS IS NOT LIMITED TO THOSE INDICATED ON THIS DRAWING. CONTRACTOR IS RESPONSIBLE FOR FIELD VERIFYING ALL EXISTING CONDITIONS & QUANTITIES AS WELL AS PROVIDING BASE BID QUANTITIES / PRICING ALONG WITH ADD/DEDUCT UNIT PRICING.

DEMOLITION KEYN O T E S:

- (A) REMOVE EXISTING CABINETS, MILLWORK, SHELVING, RODS, AND ANY ASSOCIATED TRIM.
- (B) REMOVE EXISTING STAIRCASE, HANDRAILS, BANISTERS AND CARPET
- $\langle C \rangle$ EXISTING EXT WALL TO REMAIN. REMOVE EXISTING INT AND EXT FINISHES, PREPARE EXISTING FRAMING AND SHEATHING TO RECEIVE NEW FINISHES AND BATT INSULATION. PROVIDE A TEMPORARY WEATHER BARRIER BETWEEN EXISTING WINDOW REMOVAL AND NEW WINDOW INSTALLATION.
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 angle$ remove existing floor finish down to existing floor sheathing. PREPARE EXISTING SHEATHING FOR NEW FLOOR FINISH.
- (G) REMOVE EXISTING DOOR, WINDOW, SILL, AND ASSOCIATED TRIM. PREPARE TO FILL EXISTING/NEW OPENING PER EXTERIOR ELEVATIONS WITH NEW DOORWINDOW ASSEMBLY. PROVIDE A TEMPORARY WEATHER BARRIER BETWEEN EXISTING WINDOW REMOVAL AND NEW WINDOW INSTALLATION.
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- REMOVE EXISTING DOOR.
- (J > REMOVE EXISTING FIRE PLACE AND MANTEL IN ITS ENTIRETY. MAINTAIN LOCATION OF EXISTING EXHAUST CHASE AND PREPARE FOR INSTALLATION OF A
- K REMOVE EXISTING GUTTERS AND DOWNSPOUTS. PATCH AND REPAIR EXISTING FASCIA TO RECEIVE NEW PAINT AND GUTTERS.
- (L) REMOVE EXISTING LIGHT FIXTURE. MAINTAIN EXISTING CONDUIT FOR FUTURE
- (M) REMOVE EXISTING BAY WINDOW, SILL, ASSOCIATED TRIM AND HIP ROOF ENTIRELY. PREPARE TO FILL EXISTING/NEW OPENING PER EXTERIOR ELEVATIONS WITH NEW DOOR/WINDOW ASSEMBLY. PROVIDE A TEMPORARY WEATHER BARRIER BETWEEN EXISTING WINDOW REMOVAL AND NEW WINDOW INSTALLATION.
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Kevin and Carol Ryan Townhouse Renovation

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BASEMENT EXISTING CONDITIONS / DEMOLITION PLAN

11/29/2023 23-054 JTK/ AND/ KH SMD/AND

SMD/AND








OF WORK



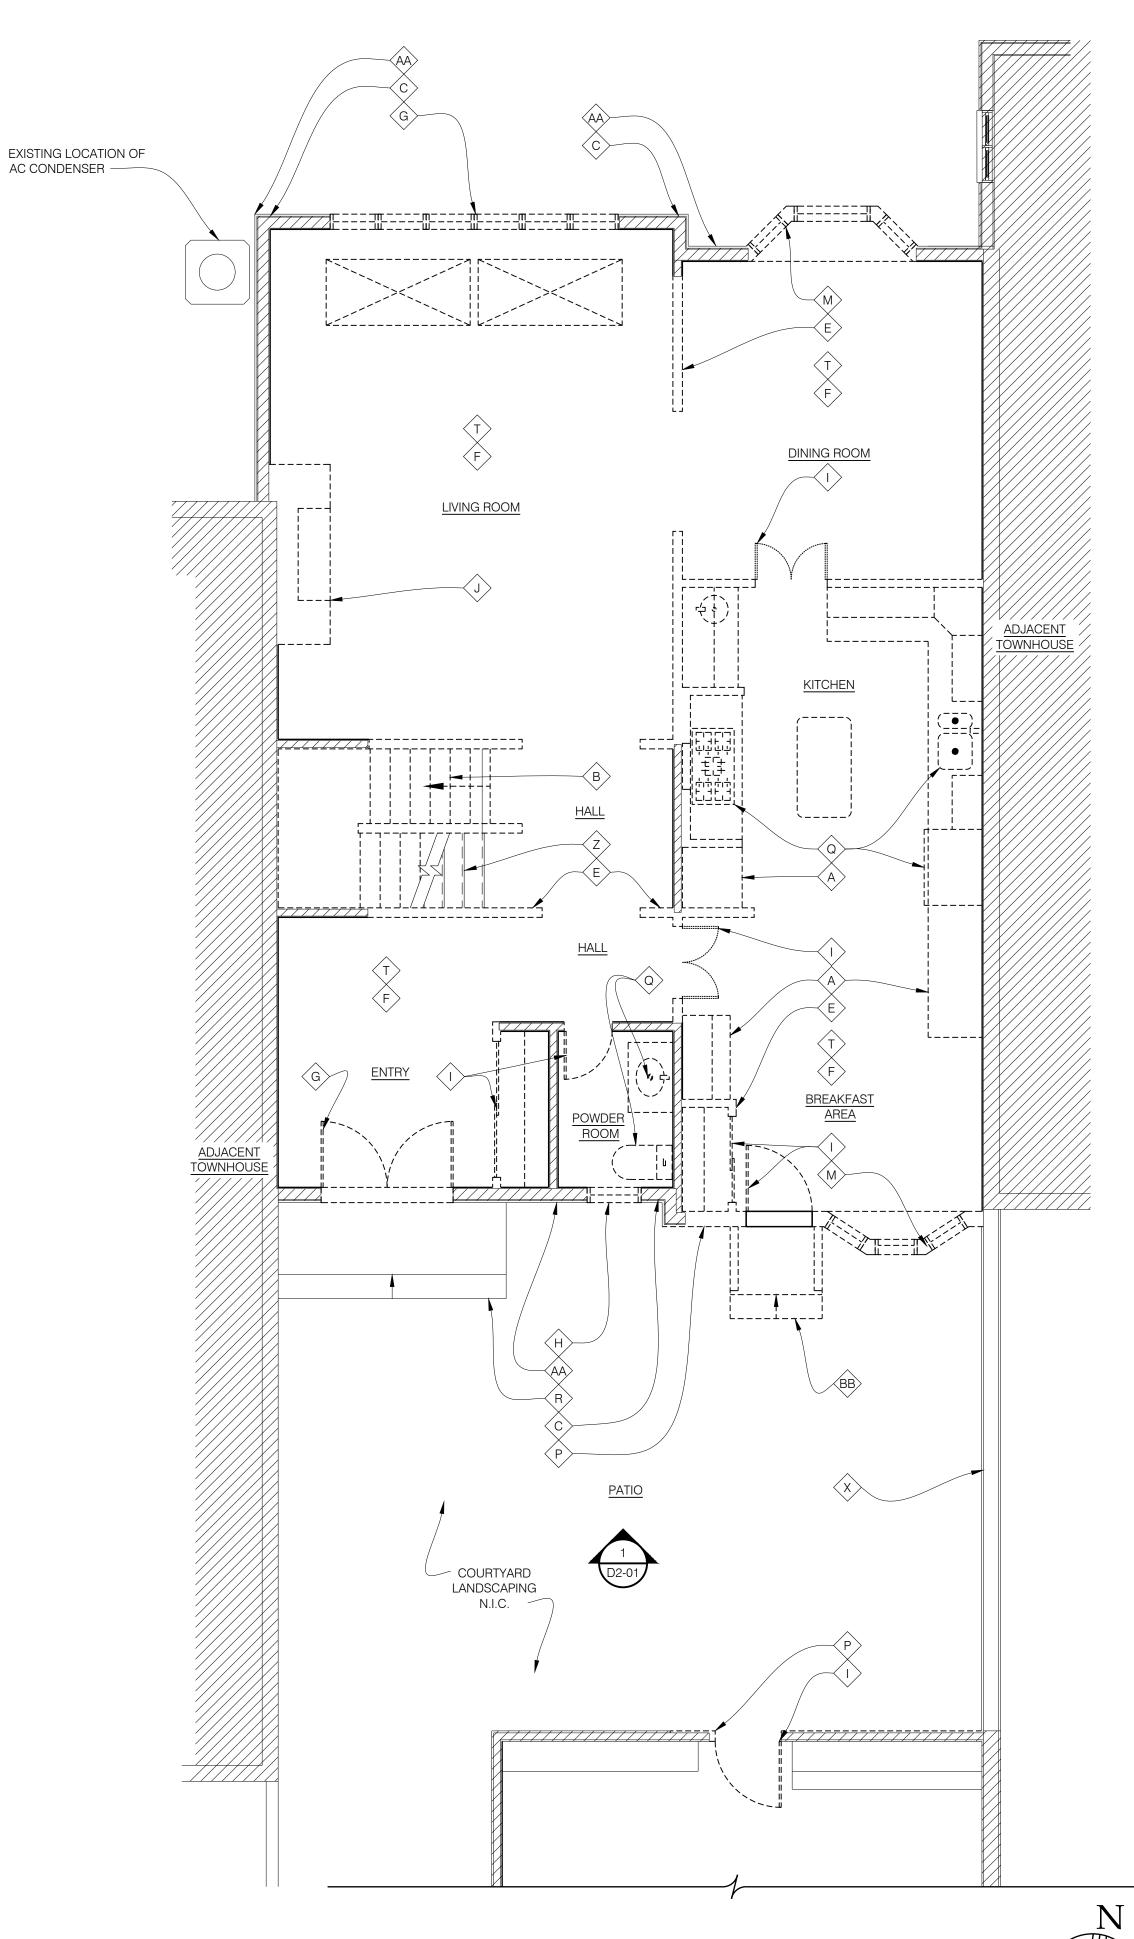



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FIRST LEVEL EXISING CONDITIONS / DEMOLITION PLAN

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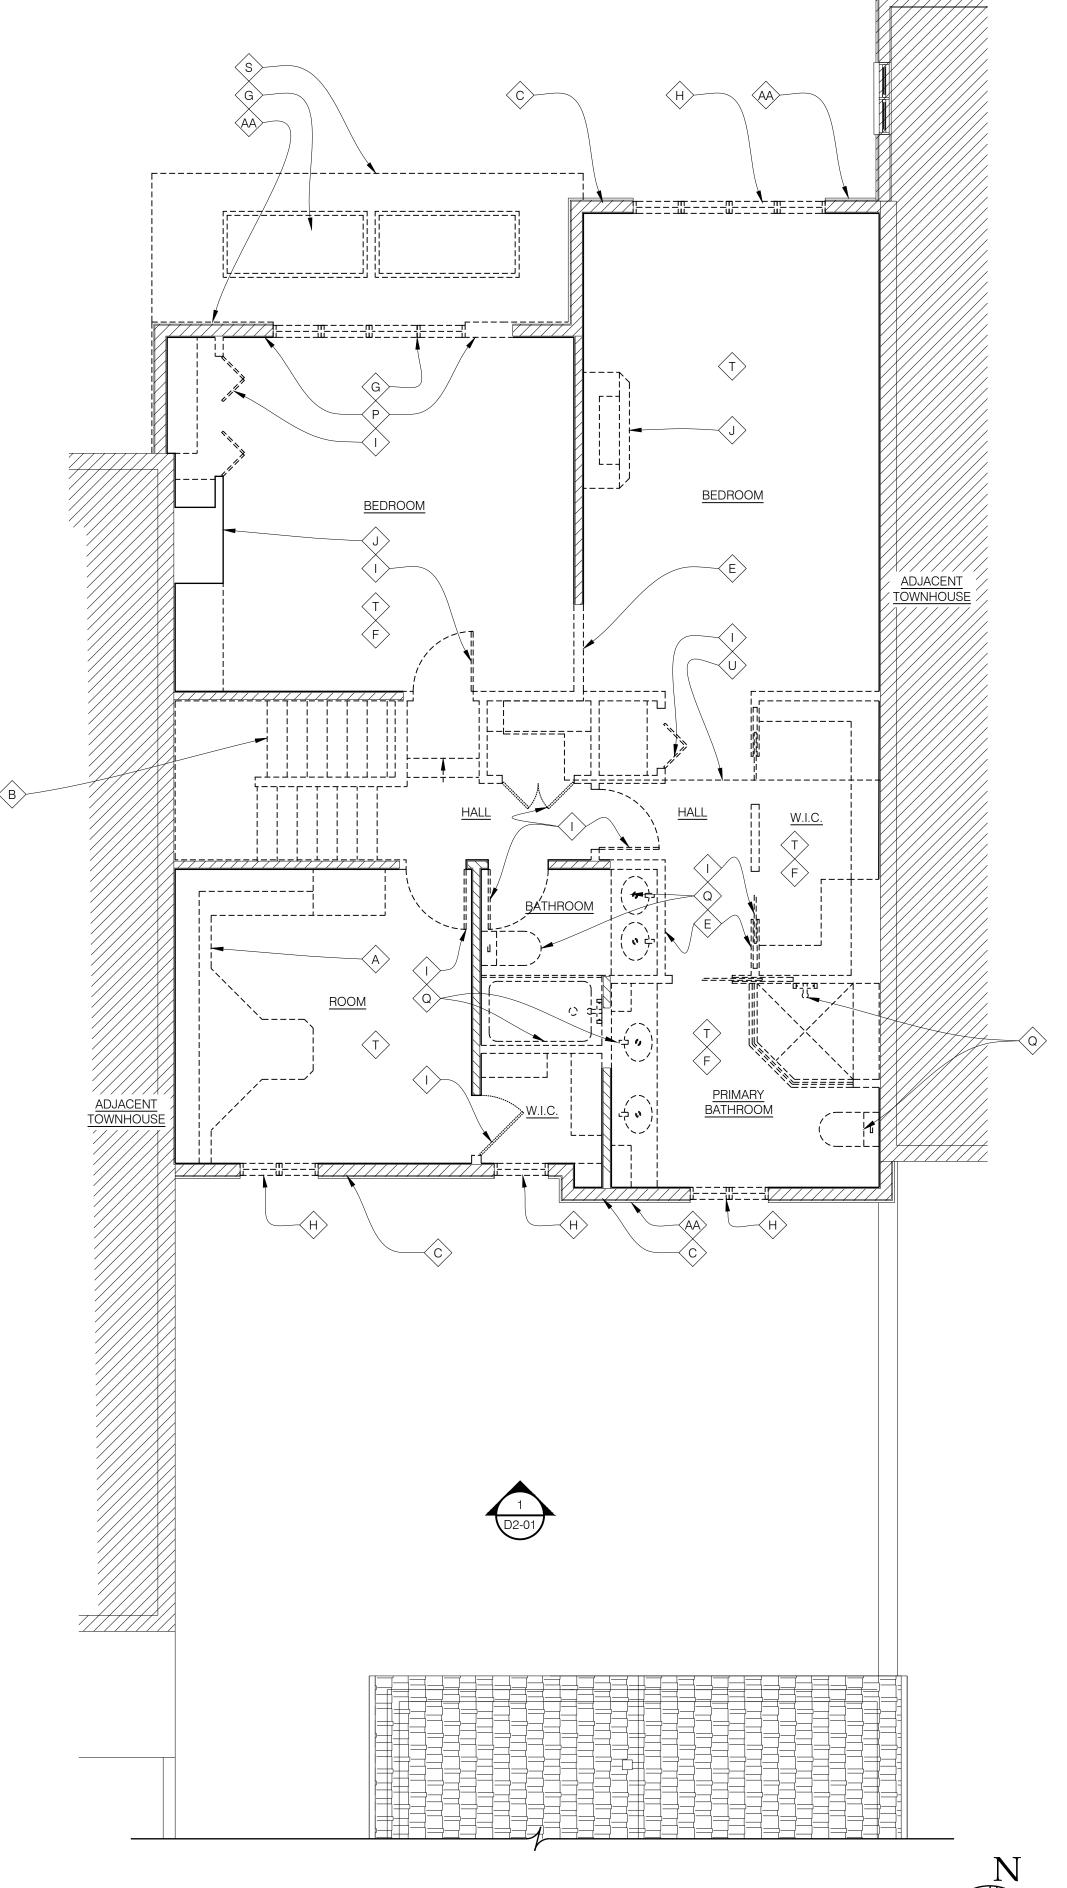
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FIRST LEVEL EXISING CONDITIONS / DEMOLITION PLAN

SCALE: 1/4" = 1'-0"







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- CONTRACTOR TO REMOVE FROM THE SITE AND LEGALLY DISPOSE OF DAILY REFUSE, DEBRIS, RUBBISH, AND OTHER MATERIALS RESULTING FROM DEMOLITION ACTIVITIES. CONTRACTOR SHALL MAINTAIN A REFUSE DUMPSTER ON SITE IF NECESSARY. COORDINATE LOCATION WITH BUILDING OWNER. DEMOLITION SPACE SHALL BE LEFT BROOM-CLEAN AND READY TO RECEIVE NEW CONSTRUCTION.
- 5. REMOVE ALL ELECTRICAL, LIGHTING, TV CABLE, TELEPHONE WIRE AND OUTLET WIRING AND CONDUIT, PLUMBING PIPING, FIXTURES AND FIRE SUPPRESSION, AND MECHANICAL DUCTWORK THAT IS NOT INDICATED TO BE RE-USED IN THE MECHANICAL AND ELECTRICAL DOCUMENTS. COORDINATE UTILITY DISCONNECT WITH UTILITY COMPANY AND BUILDING
- 6. CONTACT ARCHITECT AND/OR OWNER IF DEMOLITION OR REMOVAL OF ANY ITEM NOT SPECIFICALLY IDENTIFIED IS IN QUESTION. ANY RADON TESTING REQUIRED TO BE OWNER PROVIDED.
- 7. CONTRACTORS SHALL VISIT AND INSPECT EXISTING BUILDING SITE AND BECOME FAMILIAR WITH ALL CONDITIONS IN FIELD PRIOR TO SUBMITTING A BID FOR DEMOLITION WORK.
- 8. THE SCOPE OF REPAIRS IS NOT LIMITED TO THOSE INDICATED ON THIS DRAWING. CONTRACTOR IS RESPONSIBLE FOR FIELD VERIFYING ALL EXISTING CONDITIONS & QUANTITIES AS WELL AS PROVIDING BASE BID QUANTITIES / PRICING ALONG WITH ADD/DEDUCT UNIT PRICING.

DEMOLITION KEYN O T E S:

- (A) REMOVE EXISTING CABINETS, MILLWORK, SHELVING, RODS, AND ANY ASSOCIATED TRIM.
- (B) REMOVE EXISTING STAIRCASE, HANDRAILS, BANISTERS AND CARPET
- $\langle c \rangle$ Existing ext wall to remain. Remove existing int and ext finishes, PREPARE EXISTING FRAMING AND SHEATHING TO RECEIVE NEW FINISHES AND BATT INSULATION. PROVIDE A TEMPORARY WEATHER BARRIER BETWEEN EXISTING WINDOW REMOVAL AND NEW WINDOW INSTALLATION.
- (D) EXISTING BRICK WALL TO REMAIN. REMOVE EXISTING INT FINISHES, PREPARE EXISTING FRAMING AND SHEATHING TO RECEIVE NEW FINISHES AND BATT INSULATION. PROVIDE A TEMPORARY WEATHER BARRIER BETWEEN EXISTING WINDOW REMOVAL AND NEW WINDOW INSTALLATION.
- $\langle \mathsf{E}
 angle$ REMOVE EXISTING PARTITION STUD WALL AND ASSOCIATED TRIM.
- $\langle \mathsf{F}
 angle$ remove existing floor finish down to existing floor sheathing. PREPARE EXISTING SHEATHING FOR NEW FLOOR FINISH.
- (G) REMOVE EXISTING DOOR, WINDOW, SILL, AND ASSOCIATED TRIM. PREPARE TO FILL EXISTING/NEW OPENING PER EXTERIOR ELEVATIONS WITH NEW DOORWINDOW ASSEMBLY. PROVIDE A TEMPORARY WEATHER BARRIER BETWEEN EXISTING WINDOW REMOVAL AND NEW WINDOW INSTALLATION.
- (H) EXISTING WINDOW/ DOOR, SILL, AND ASSOCIATED TRIM TO BE REMOVED AND REPLACED WITH A NEW WINDOW TO MATCH EXISTING.
- REMOVE EXISTING DOOR.
- (J > REMOVE EXISTING FIRE PLACE AND MANTEL IN ITS ENTIRETY. MAINTAIN LOCATION OF EXISTING EXHAUST CHASE AND PREPARE FOR INSTALLATION OF A
- K REMOVE EXISTING GUTTERS AND DOWNSPOUTS. PATCH AND REPAIR EXISTING FASCIA TO RECEIVE NEW PAINT AND GUTTERS.
- (L) REMOVE EXISTING LIGHT FIXTURE. MAINTAIN EXISTING CONDUIT FOR FUTURE
- (M) REMOVE EXISTING BAY WINDOW, SILL, ASSOCIATED TRIM AND HIP ROOF ENTIRELY. PREPARE TO FILL EXISTING/NEW OPENING PER EXTERIOR ELEVATIONS WITH NEW DOOR/WINDOW ASSEMBLY. PROVIDE A TEMPORARY WEATHER BARRIER BETWEEN EXISTING WINDOW REMOVAL AND NEW WINDOW INSTALLATION.
- REMOVE EXISTING EXTERIOR FINISH AND WEATHER BARRIER. PATCH AND REPAIR EXISTING SHEATHING AND PREPARE FOR NEW FINISH INSTALLATION.
- O REMOVE EXISTING EXTERIOR TRIM
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- Q REMOVE EXISTING PLUMBING, PIPING, AND FIXTURES.
- $\langle R \rangle$ EXISTING EXTERIOR BRICK STEPS TO REMAIN
- REMOVE PORTION OF EXISTING ROOF, REFER TO ELEVATIONS, BRACE AND PREPARE FOR STRUCTURE AT NEW OPENING. PROVIDE A TEMPORARY WEATHER BARRIER BETWEEN EXISTING WINDOW REMOVAL AND NEW WINDOW INSTALLATION.
- T REMOVE EXISTING WALL FINISH. PREPARE EXISTING FRAMING TO REMAIN TO RECEIVE NEW GYP. BD. EXISTING WALL FINISH TO REMAIN WHERE APPLICABLE. PATCH AND REPAIR EXISTING DRYWALL AND PREPARE FOR NEW COAT OF PAINT
- (U) REMOVE PORTION OF EXISTING FLOORING, STRUCTURAL JOISTS AND CEILING FINISH BELOW
- (V) EXISTING SKYLIGHT TO REMAIN
- (W) ALL EXISTING MECHANICAL, ELECTRICAL AND PLUMBING SYSTEMS TO REMAIN WHERE APPLICABLE. GENERAL CONTRACTOR TO FIELD VERIFY CURRENT CONDITION AND OPERABILITY PRIOR TO CONDUCTING ANY FINISH WORK.
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- Y EXISTING TRIM TO REMAIN
- Z EXISTING STAIRCASE FRAMING TO REMAIN. REMOVE EXISTING WOOD/ CARPET AND PREPARE TO RECEIVE NEW FINISH
- AA EXISTING EXTERIOR FINISH TO REMAIN. PATCH AND REPAIR EXISTING AS
- (BB) EXISTING EXTERIOR BRICK STEPS TO BE REMOVED
- CC EXISTING WATER SUPPLY MANIFOLD TO REMAIN. CONFIRM SHUT-OFF PRIOR TO CONSTRUCTION AND CONFIRM FUNCTIONALITY WITH ANY NEW PLUMBING



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PRICING SET-VE REVISION	10/26/23	SMD
REVIEW SET	11/29/23	SMD



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SECOND LEVEL EXISTING CONDITIONS/ DEMOLITION PLAN

11/29/2023 | 23-054 JTK/ AND/ KH SMD/AND


SMD/AND



OF WORK





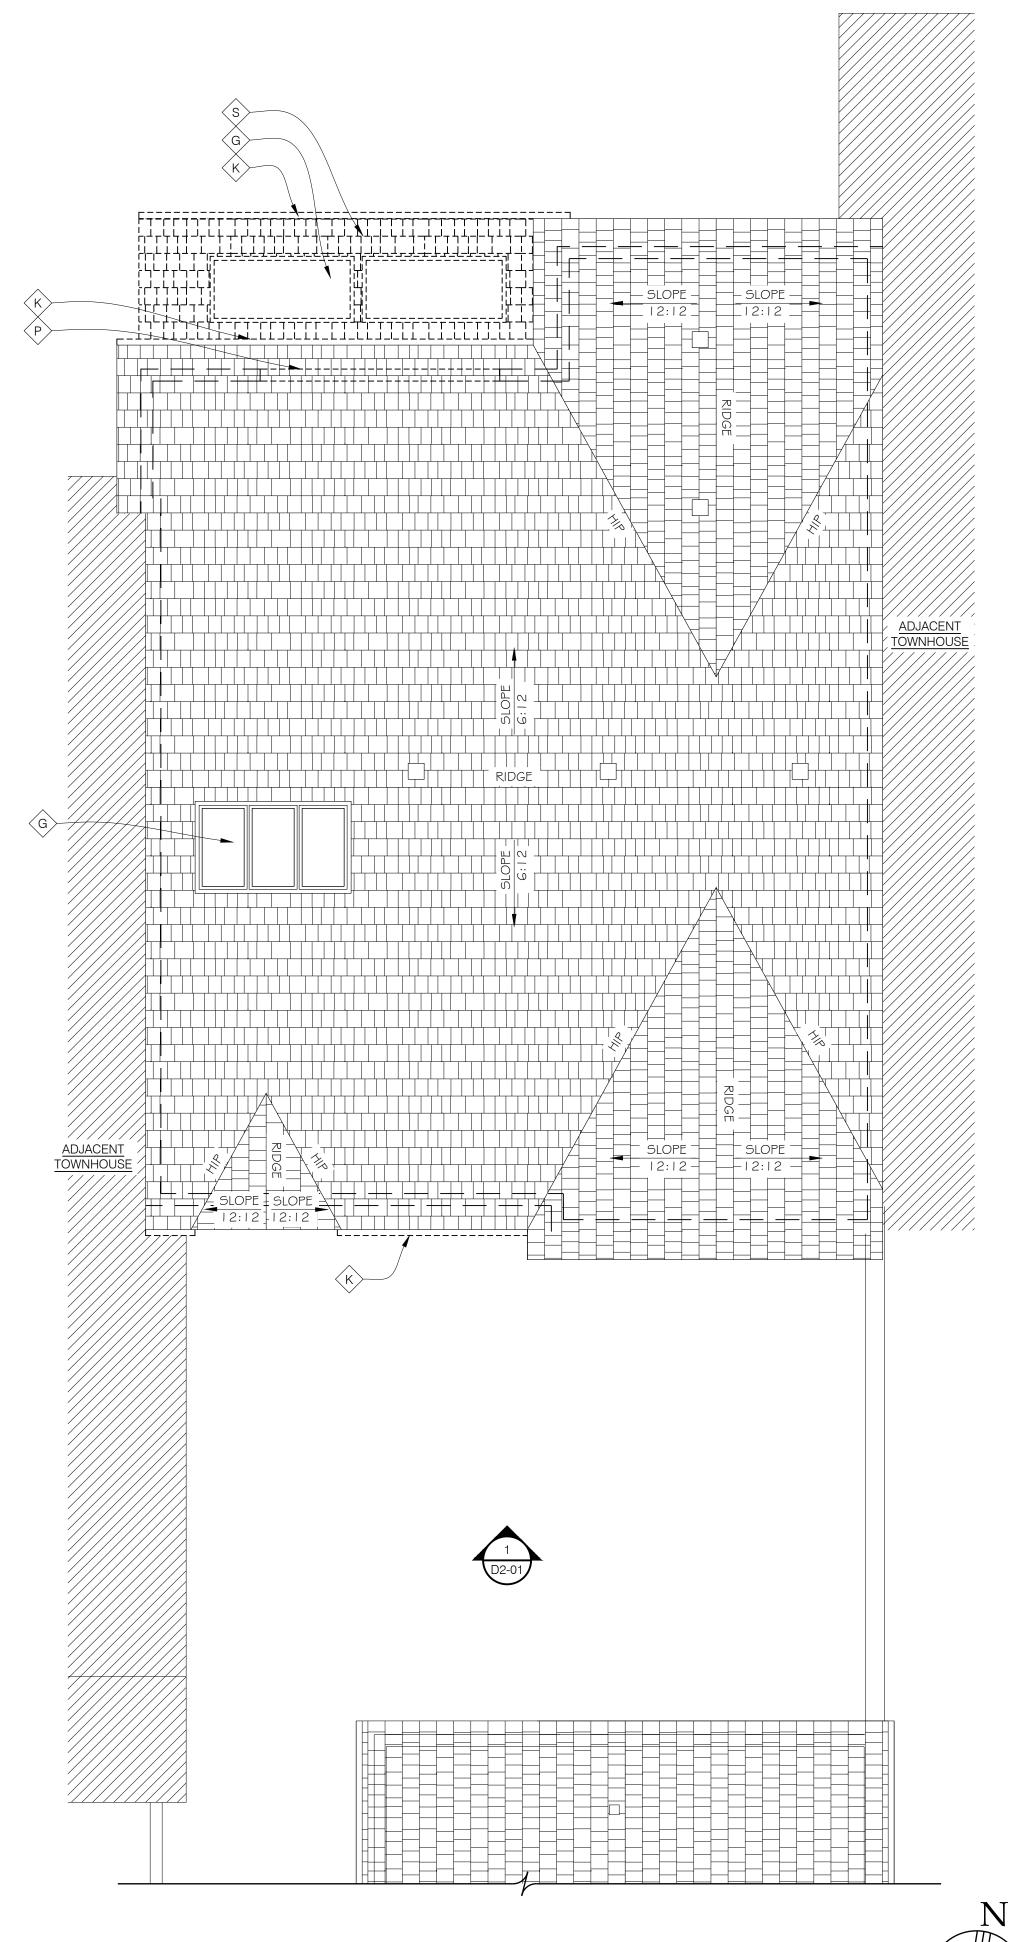



- I. DEMOLITION SHALL NOT BE LIMITED TO THE ITEMS SPECIFICALLY SHOWN IN THE DRAWINGS. THE INTENT IS TO SHOW THE GENERAL SCOPE OF DEMOLITION REQUIRED TO PREPARE THE SPACES FOR NEW CONSTRUCTION.
- 2. CONTRACTOR TO COMPLY WITH ALL APPLICABLE LOCAL, STATE, AND FEDERAL CODES AS WELL AS ALL OSHA REGULATIONS TO PROTECT SAFETY OF WORKERS, PROPERTY, AND INSURE ENVIRONMENTAL PROTECTION.
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- 5. REMOVE ALL ELECTRICAL, LIGHTING, TV CABLE, TELEPHONE WIRE AND OUTLET WIRING AND CONDUIT, PLUMBING PIPING, FIXTURES AND FIRE SUPPRESSION, AND MECHANICAL DUCTWORK THAT IS NOT INDICATED TO BE RE-USED IN THE MECHANICAL AND ELECTRICAL DOCUMENTS. COORDINATE UTILITY DISCONNECT WITH UTILITY COMPANY AND BUILDING
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DEMOLITION KEYN O T E S:

- A REMOVE EXISTING CABINETS, MILLWORK, SHELVING, RODS, AND ANY ASSOCIATED TRIM.
- (B) REMOVE EXISTING STAIRCASE, HANDRAILS, BANISTERS AND CARPET
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 angle$ EXISTING EXT WALL TO REMAIN. REMOVE EXISTING INT AND EXT FINISHES. PREPARE EXISTING FRAMING AND SHEATHING TO RECEIVE NEW FINISHES AND BATT INSULATION. PROVIDE A TEMPORARY WEATHER BARRIER BETWEEN EXISTING WINDOW REMOVAL AND NEW WINDOW INSTALLATION.
- (D) EXISTING BRICK WALL TO REMAIN. REMOVE EXISTING INT FINISHES, PREPARE EXISTING FRAMING AND SHEATHING TO RECEIVE NEW FINISHES AND BATT INSULATION. PROVIDE A TEMPORARY WEATHER BARRIER BETWEEN EXISTING WINDOW REMOVAL AND NEW WINDOW INSTALLATION.
- (E) REMOVE EXISTING PARTITION STUD WALL AND ASSOCIATED TRIM.
- F REMOVE EXISTING FLOOR FINISH DOWN TO EXISTING FLOOR SHEATHING. PREPARE EXISTING SHEATHING FOR NEW FLOOR FINISH.
- (G) REMOVE EXISTING DOOR, WINDOW, SILL, AND ASSOCIATED TRIM. PREPARE TO FILL EXISTING/NEW OPENING PER EXTERIOR ELEVATIONS WITH NEW DOOR, WINDOW ASSEMBLY. PROVIDE A TEMPORARY WEATHER BARRIER BETWEEN EXISTING WINDOW REMOVAL AND NEW WINDOW INSTALLATION.
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- (L) REMOVE EXISTING LIGHT FIXTURE. MAINTAIN EXISTING CONDUIT FOR FUTURE FIXTURE
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- $\langle {\sf Q}
 angle$ remove existing plumbing, piping, and fixtures.
- (R) EXISTING EXTERIOR BRICK STEPS TO REMAIN
- (S) REMOVE PORTION OF EXISTING ROOF, REFER TO ELEVATIONS, BRACE AND PREPARE FOR STRUCTURE AT NEW OPENING. PROVIDE A TEMPORARY WEATHER BARRIER BETWEEN EXISTING WINDOW REMOVAL AND NEW WINDOW INSTALLATION.
- T REMOVE EXISTING WALL FINISH. PREPARE EXISTING FRAMING TO REMAIN TO RECEIVE NEW GYP. BD. EXISTING WALL FINISH TO REMAIN WHERE APPLICABLE. PATCH AND REPAIR EXISTING DRYWALL AND PREPARE FOR NEW COAT OF PAINT
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- V EXISTING SKYLIGHT TO REMAIN
- W ALL EXISTING MECHANICAL, ELECTRICAL AND PLUMBING SYSTEMS TO REMAIN WHERE APPLICABLE. GENERAL CONTRACTOR TO FIELD VERIFY CURRENT CONDITION AND OPERABILITY PRIOR TO CONDUCTING ANY FINISH WORK.
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ROOF EXISTING CONDITIONS/ DEMOLITION PLAN

11/29/2023 23-054 JTK/ AND/ KH SMD/AND


SMD/AND







OF WORK

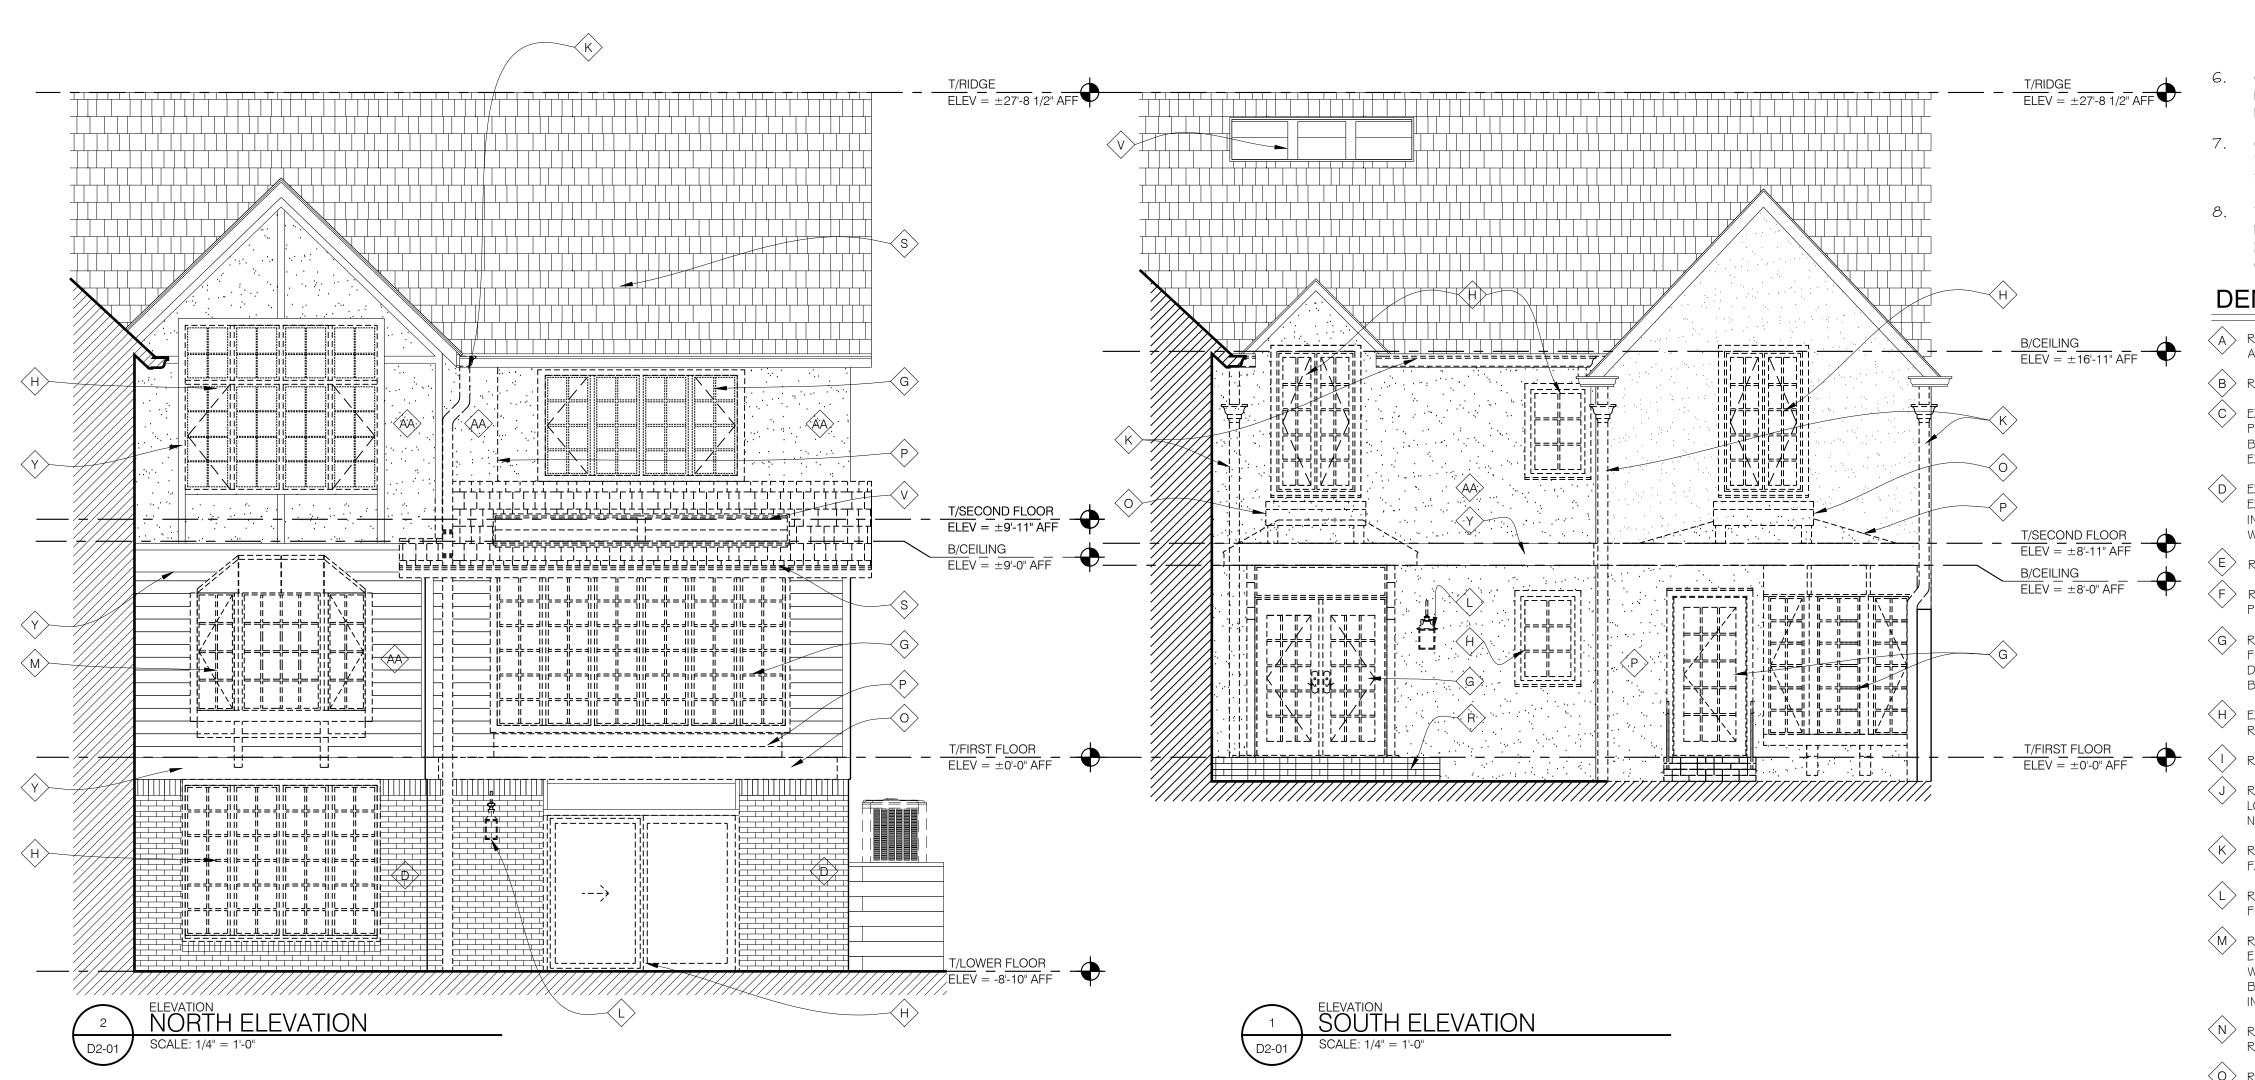



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- REMOVE ALL ELECTRICAL, LIGHTING, TV CABLE, TELEPHONE WIRE AND OUTLET WIRING AND CONDUIT, PLUMBING PIPING, FIXTURES AND FIRE SUPPRESSION, AND MECHANICAL DUCTWORK THAT IS NOT INDICATED TO BE RE-USED IN THE MECHANICAL AND ELECTRICAL DOCUMENTS. COORDINATE UTILITY DISCONNECT WITH UTILITY COMPANY AND BUILDING
- CONTACT ARCHITECT AND/OR OWNER IF DEMOLITION OR REMOVAL OF ANY ITEM NOT SPECIFICALLY IDENTIFIED IS IN QUESTION. ANY RADON TESTING REQUIRED TO BE OWNER PROVIDED.
- 7. CONTRACTORS SHALL VISIT AND INSPECT EXISTING BUILDING SITE AND BECOME FAMILIAR WITH ALL CONDITIONS IN FIELD PRIOR TO SUBMITTING A BID FOR DEMOLITION WORK.
- 8. THE SCOPE OF REPAIRS IS NOT LIMITED TO THOSE INDICATED ON THIS DRAWING. CONTRACTOR IS RESPONSIBLE FOR FIELD VERIFYING ALL EXISTING CONDITIONS & QUANTITIES AS WELL AS PROVIDING BASE BID QUANTITIES / PRICING ALONG WITH ADD/DEDUCT UNIT PRICING.

DEMOLITION KEYN O T E S :

- (A) REMOVE EXISTING CABINETS, MILLWORK, SHELVING, RODS, AND ANY ASSOCIATED TRIM.
- (B) REMOVE EXISTING STAIRCASE, HANDRAILS, BANISTERS AND CARPET
- $^{\circ}$ EXISTING EXT WALL TO REMAIN. REMOVE EXISTING INT AND EXT FINISHES, PREPARE EXISTING FRAMING AND SHEATHING TO RECEIVE NEW FINISHES AND BATT INSULATION. PROVIDE A TEMPORARY WEATHER BARRIER BETWEEN EXISTING WINDOW REMOVAL AND NEW WINDOW INSTALLATION.
- (D) EXISTING BRICK WALL TO REMAIN. REMOVE EXISTING INT FINISHES, PREPARE EXISTING FRAMING AND SHEATHING TO RECEIVE NEW FINISHES AND BATT INSULATION. PROVIDE A TEMPORARY WEATHER BARRIER BETWEEN EXISTING WINDOW REMOVAL AND NEW WINDOW INSTALLATION.
- REMOVE EXISTING PARTITION STUD WALL AND ASSOCIATED TRIM.
- REMOVE EXISTING FLOOR FINISH DOWN TO EXISTING FLOOR SHEATHING. PREPARE EXISTING SHEATHING FOR NEW FLOOR FINISH.
- REMOVE EXISTING DOOR, WINDOW, SILL, AND ASSOCIATED TRIM. PREPARE TO FILL EXISTING/NEW OPENING PER EXTERIOR ELEVATIONS WITH NEW DOOR/WINDOW ASSEMBLY. PROVIDE A TEMPORARY WEATHER BARRIER BETWEEN EXISTING WINDOW REMOVAL AND NEW WINDOW INSTALLATION.
- (H) EXISTING WINDOW/ DOOR, SILL, AND ASSOCIATED TRIM TO BE REMOVED AND REPLACED WITH A NEW WINDOW TO MATCH EXISTING.
- REMOVE EXISTING DOOR.
- REMOVE EXISTING FIRE PLACE AND MANTEL IN ITS ENTIRETY. MAINTAIN LOCATION OF EXISTING EXHAUST CHASE AND PREPARE FOR INSTALLATION OF A
- K REMOVE EXISTING GUTTERS AND DOWNSPOUTS. PATCH AND REPAIR EXISTING FASCIA TO RECEIVE NEW PAINT AND GUTTERS.
- (L) REMOVE EXISTING LIGHT FIXTURE. MAINTAIN EXISTING CONDUIT FOR FUTURE FIXTURE
- (M) REMOVE EXISTING BAY WINDOW, SILL, ASSOCIATED TRIM AND HIP ROOF ENTIRELY. PREPARE TO FILL EXISTING/NEW OPENING PER EXTERIOR ELEVATIONS WITH NEW DOOR/WINDOW ASSEMBLY. PROVIDE A TEMPORARY WEATHER BARRIER BETWEEN EXISTING WINDOW REMOVAL AND NEW WINDOW INSTALLATION.
- $\langle \mathsf{N} \rangle$ remove existing exterior finish and weather barrier. Patch and REPAIR EXISTING SHEATHING AND PREPARE FOR NEW FINISH INSTALLATION.
- O REMOVE EXISTING EXTERIOR TRIM
- P REMOVE PORTION EXISTING EXTERIOR WALL, REFER TO ELEVATIONS. BRACE AND PREPARE FOR STRUCTURE AT NEW OPENING. PROVIDE A TEMPORARY WEATHER BARRIER BETWEEN EXISTING WINDOW REMOVAL AND NEW WINDOW INSTALLATION.
- $\langle \mathsf{Q}
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- R EXISTING EXTERIOR BRICK STEPS TO REMAIN
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- T REMOVE EXISTING WALL FINISH. PREPARE EXISTING FRAMING TO REMAIN TO RECEIVE NEW GYP. BD. EXISTING WALL FINISH TO REMAIN WHERE APPLICABLE. PATCH AND REPAIR EXISTING DRYWALL AND PREPARE FOR NEW COAT OF PAINT
- (U) REMOVE PORTION OF EXISTING FLOORING, STRUCTURAL JOISTS AND CEILING FINISH BELOW
- (V) EXISTING SKYLIGHT TO REMAIN
- W ALL EXISTING MECHANICAL, ELECTRICAL AND PLUMBING SYSTEMS TO REMAIN WHERE APPLICABLE. GENERAL CONTRACTOR TO FIELD VERIFY CURRENT CONDITION AND OPERABILITY PRIOR TO CONDUCTING ANY FINISH WORK.
- X EXISTING CMU DEMISING WALL TO REMAIN. GENERAL CONTRACTOR TO FIELD VERIFY STRUCTURAL INTEGRITY.
- Y EXISTING TRIM TO REMAIN
- $\langle z \rangle$ Existing staircase framing to remain. Remove existing wood/ carpet AND PREPARE TO RECEIVE NEW FINISH
- EXISTING EXTERIOR FINISH TO REMAIN. PATCH AND REPAIR EXISTING AS NEEDED
- (BB) EXISTING EXTERIOR BRICK STEPS TO BE REMOVED
- CO EXISTING WATER SUPPLY MANIFOLD TO REMAIN. CONFIRM SHUT-OFF PRIOR TO CONSTRUCTION AND CONFIRM FUNCTIONALITY WITH ANY NEW PLUMBING

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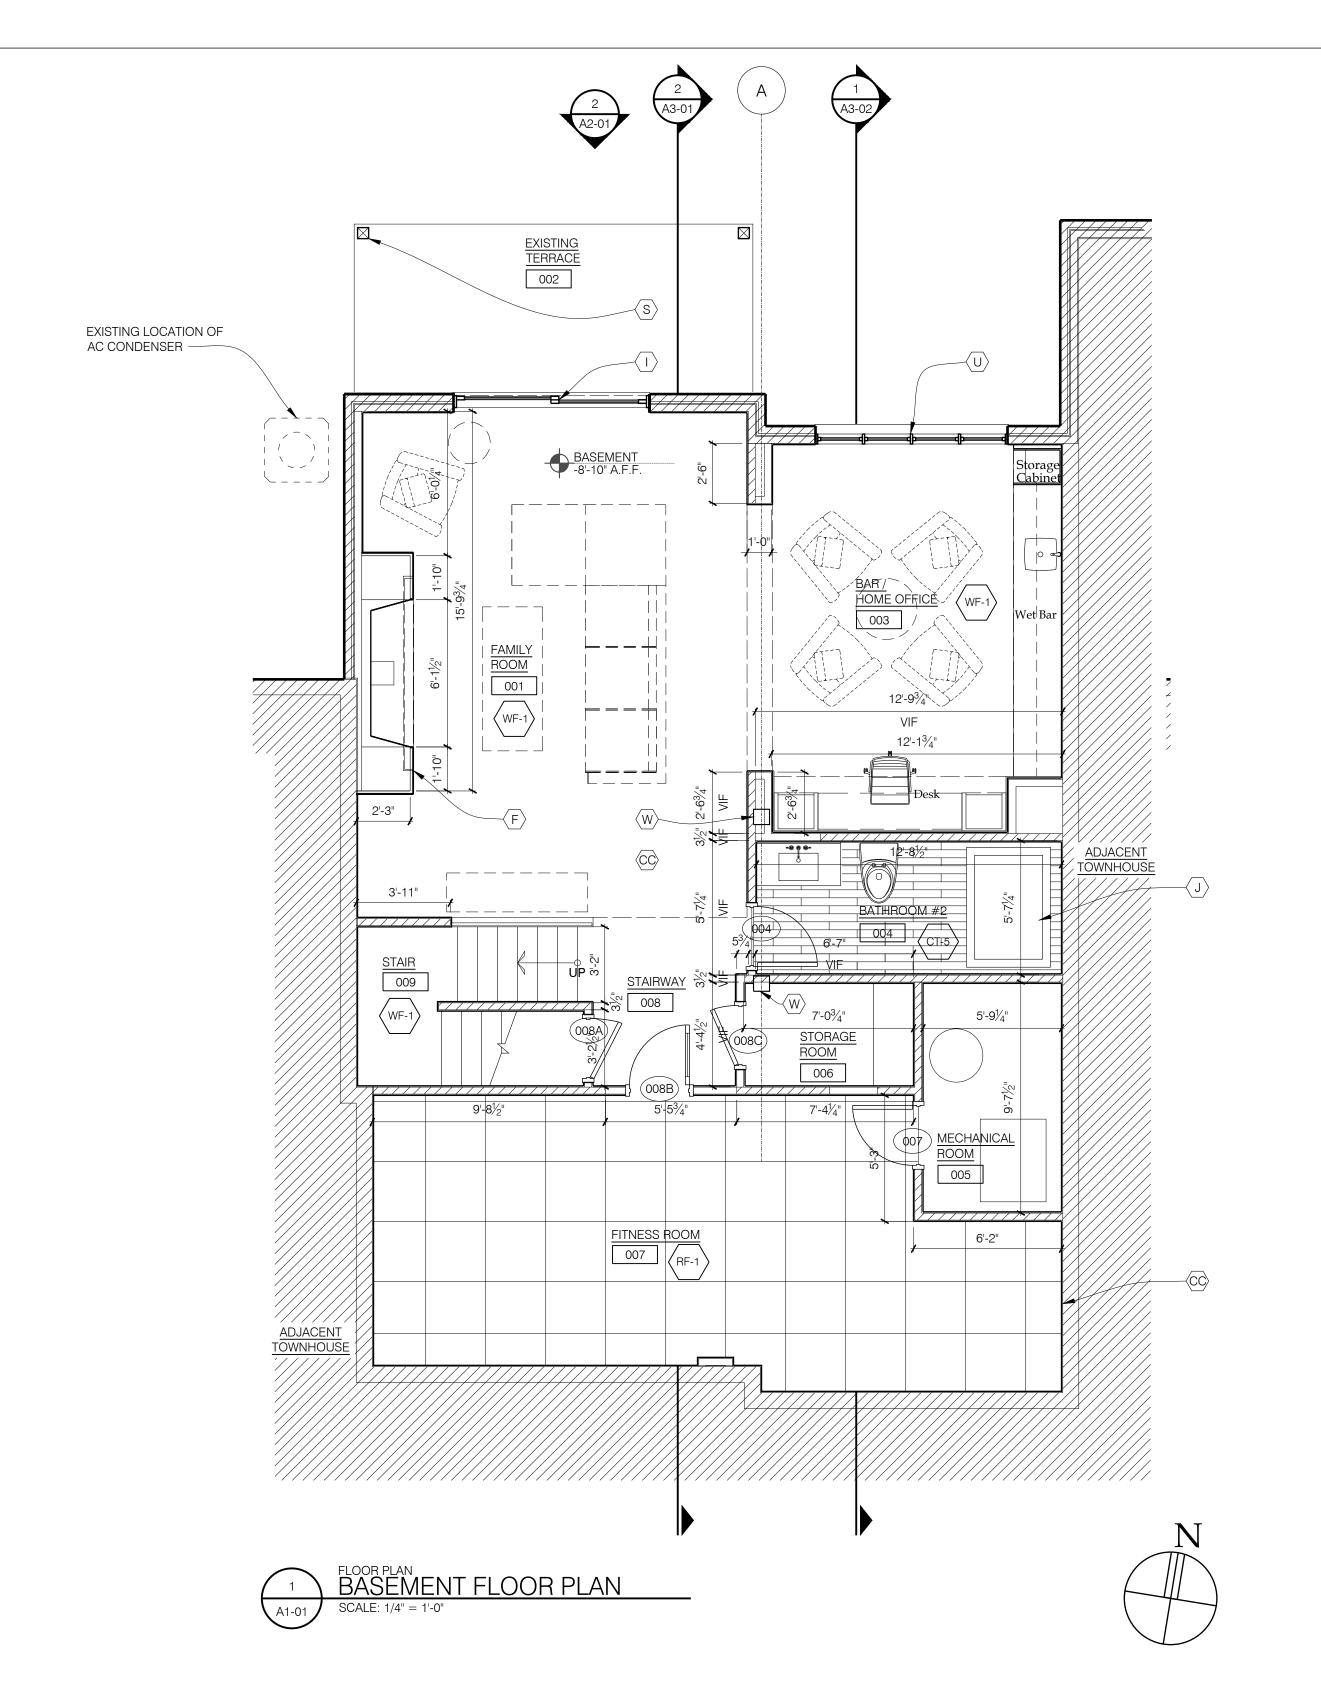
DEMOLITION ELEVATIONS

11/29/2023 | 23-054 JTK/ AND/ KH

SMD/AND SMD/AND

HATCHED AREA NOT IN SCOPE OF WORK





- I. GENERAL CONTRACTOR \$ ALL SUBCONTRACTORS TO FIELD VERIFY ALL EXISTING CONDITIONS, EXAMINE THE ENTIRE SITE AND THE CONSTRCTION DOCUMENTS TO ENSURE THEIR KNOWLEDGE OF ALL RELEVANT EXISTING FIELD CONDITIONS AFFECTING THE SCOPE OF WORK PRIOR TO PRICING. ANY DESCREPANCIES OR CONFLICTS BETWEEN THE ARCHITECTURAL AND ENGINEERING DOCUMENTS AND FIELD CONDITIONS SHALL BE CLARIFIED WITH THE ARCHITECT AND ENGINEER BEFORE INITIATING WORK.
- 2. IT IS THE RESPONSIBILITY OF THE GENERAL CONTRACTOR TO OBTAIN ACCURATE FIELD MEASUREMENTS AND VERIFY ALL DIMENSIONS AND TO PROVIDE SHOP DRAWINGS TO ENSURE AN ACCURATE FIT. NO CLAIM FOR EXTRA COMPENSATION WILL BE ALLOWED BASED ON FAILURE TO IDENTIFY EXISTING FIELD CONDITIONS.
- 3. GENERAL CONTRACTOR SHALL REPORT TO THE ARCHITECT ANY ERRORS, INCONSISENSCIES OR OMMISSIONS THEY MAY DISCOVER PRIOR TO THE COMMENCING OF WORK WITH THE REQUEST FOR INFORMATION (RFI) FORM.
- 4. DIMENSIONS TAKE PRECEDENCE OVER DRAWINGS. ALL DIMENSIONS ARE FROM FACE OF FINISH OF WALL (TYPICAL UNLESS OTHERWISE NOTED). DO NOT SCALE.
- 5. ALL DOOR ROUGH OPENINGS ARE TO BE LOCATED 3" FROM NEAREST WALL AT HINGE SIDE (TYPICAL UNLESS OTHERWISE NOTED).

NEW CONSTRUCTION KEYN O T E S :

- (A) EXTERIOR WALL INFILL TO MATCH EXISTING.
- (B) NEW WOOD FRAMED ENTRY CANOPY WITH STANDING SEAM METAL ROOF AND FLANKING WOOD SUPPORT BRACKETS
- C NEW GUTTERS AND DOWNSPOUTS
- D OPEN TREAD OAK STAIR CASE WITH GLASS RAILINGS AND METAL HANDRAIL
- (E) EXISTING SKYLIGHT TO REMAIN
- F NEW GAS INSERT FIRE PLACE AND MANTEL WITH SPACE FOR LARGE FLAT SCREEN TV ABOVE
- G NEW KITCHEN COUNTERTOPS, CABINETS, AND APPLIANCES
- $\langle H \rangle$ EXISTING ENTRY STEPS TO REMAIN
- (I) NEW SLIDING GLASS DOOR
- J 24" DEEP PLUNGE BATH
- K POCKET GLASS DOOR PARTITION WITH DOOR RECESS
- $\overline{\langle L \rangle}$ dashed line indicates location of New Wood deck above
- M PRESSURE TREATED WOOD GUARD RAIL, 4X4 WOOD POSTS AND TAPERED TOP CAP
- N DASHED LINE INDICATES LOCATION OF SKYLIGHT ABOVE
- O DASHED LINE INDICATES LOCATION OF NEW ENTRY CANOPY ABOVE
- $\left\langle \mathbf{P} \right\rangle$ EXISTING CMU DEMISING WALL TO REMAIN
- $\langle {\sf Q} \rangle$ SLIDING PARTITION WALL ENCLOSING HOME OFFICE
- S COMPOSITE WOOD DECK WITH PRESSURE TREATED 6X6 WOOD POSTS, REFER TO STRUCTURAL
- T EXISTING WINDOW/ DOOR, SILL, AND ASSOCIATED TRIM TO REMAIN. PATCH AND REPAIR MILL WORK AS NEEDED.
- (U) NEW WINDOW, REFER TO ELEVATIONS
- $\langle {
 m V}
 angle$ new entry door with tempered glass side lites
- W NEW STEEL STRUCTURAL COLUMN
- $\langle \chi \rangle$ glass partition wall with glass door
- GUTTER MOUNTED TO TOP OF CMU WALL
- Z NEW FIXED SKYLIGHT CURB MOUNTED TO ROOF SHEATHING
- EXISTING WOOD FRAMED ROOF WITH SHAKE SHINGLES TO REMAIN. PATCH AND REPAIR AS NEEDED
- BB EXISTING EXTERIOR STUCCO WALL FINISH TO REMAIN. PATCH AND REPAIR AS NEEDED
- ALL EXISTING MECHANICAL, ELECTRICAL AND PLUMBING SYSTEMS TO REMAIN WHERE APPLICABLE. GENERAL CONTRACTOR TO FIELD VERIFY CURRENT CONDITION AND OPERABILITY PRIOR TO CONDUCTING ANY FINISH WORK.

HATCHED AREA NOT IN SCOPE OF WORK



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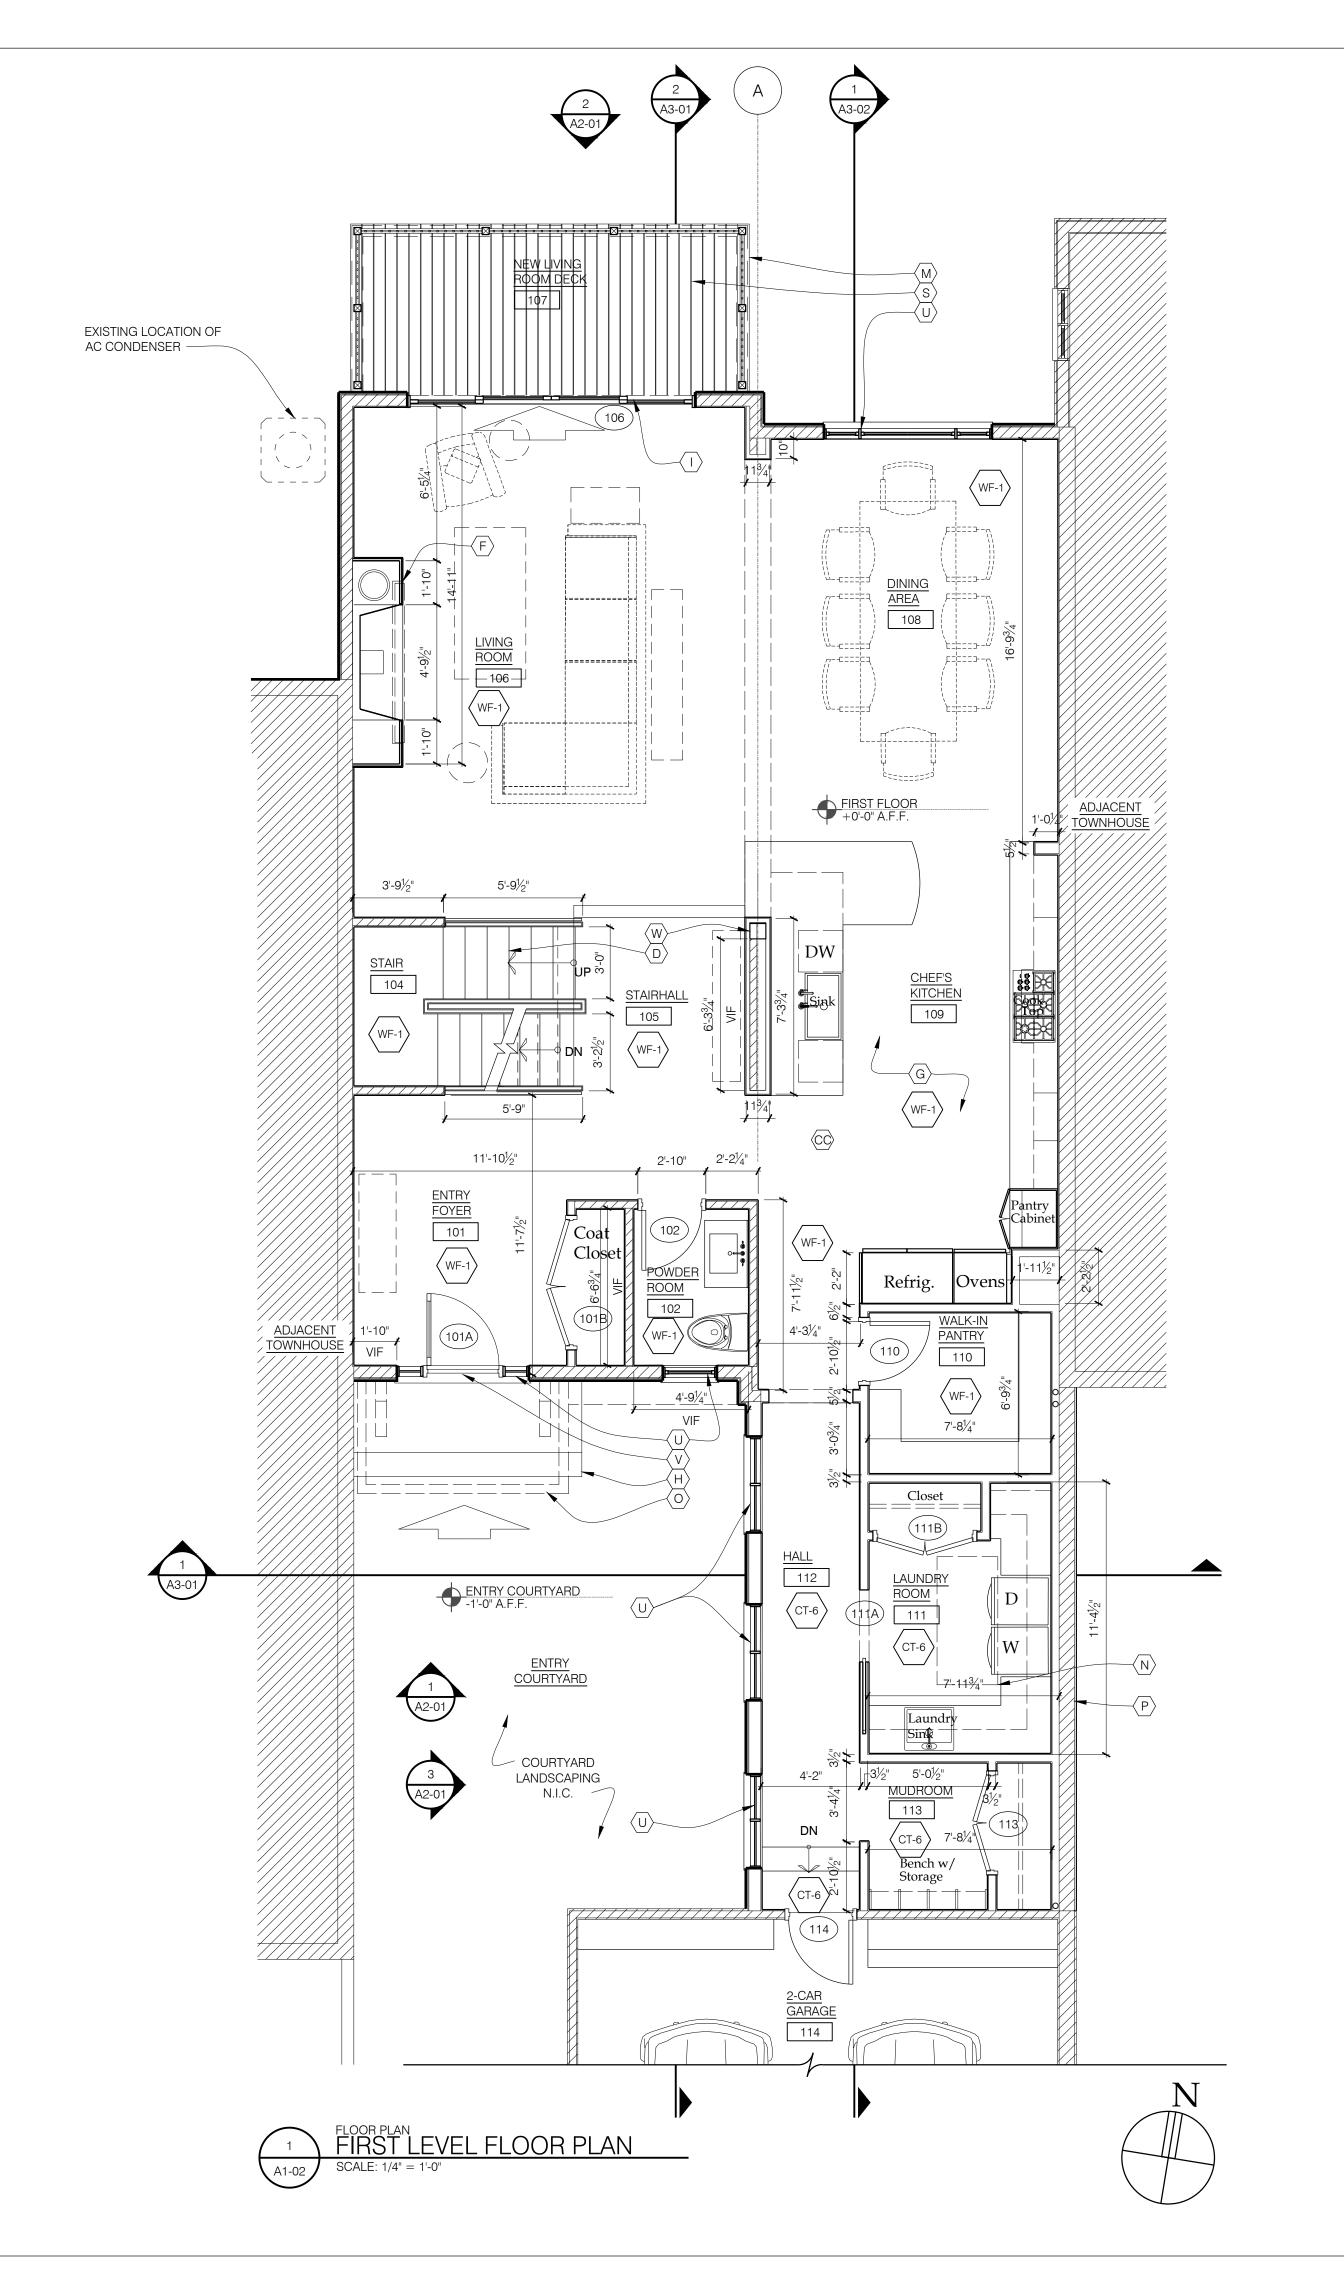
BASEMENT FLOOR PLAN

Date	Project Number	
11/29/2023	23-054	
11/20/2020	20 00 1	
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JTK/ AND/ KH		
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Drawn by
JTK/ AND/ KH
Checked by
SMD/AND
Approved
SMD/AND
Drawing Number

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- I. GENERAL CONTRACTOR & ALL SUBCONTRACTORS TO FIELD VERIFY ALL EXISTING CONDITIONS, EXAMINE THE ENTIRE SITE AND THE CONSTRCTION DOCUMENTS TO ENSURE THEIR KNOWLEDGE OF ALL RELEVANT EXISTING FIELD CONDITIONS AFFECTING THE SCOPE OF WORK PRIOR TO PRICING. ANY DESCREPANCIES OR CONFLICTS BETWEEN THE ARCHITECTURAL AND ENGINEERING DOCUMENTS AND FIELD CONDITIONS SHALL BE CLARIFIED WITH THE ARCHITECT AND ENGINEER BEFORE INITIATING WORK.
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- 4. DIMENSIONS TAKE PRECEDENCE OVER DRAWINGS. ALL DIMENSIONS ARE FROM FACE OF FINISH OF WALL (TYPICAL UNLESS OTHERWISE NOTED). DO NOT SCALE.
- 5. ALL DOOR ROUGH OPENINGS ARE TO BE LOCATED 3" FROM NEAREST WALL AT HINGE SIDE (TYPICAL UNLESS OTHERWISE NOTED).

NEW CONSTRUCTION KEYN O T E S:

- $\overline{\langle A \rangle}$ EXTERIOR WALL INFILL TO MATCH EXISTING.
- B NEW WOOD FRAMED ENTRY CANOPY WITH STANDING SEAM METAL ROOF AND FLANKING WOOD SUPPORT BRACKETS
- $\langle \mathsf{C}
 angle$ NEW GUTTERS AND DOWNSPOUTS
- $\langle \mathsf{D}
 angle$ OPEN TREAD OAK STAIR CASE WITH GLASS RAILINGS AND METAL HANDRAIL
- (E) EXISTING SKYLIGHT TO REMAIN
- F NEW GAS INSERT FIRE PLACE AND MANTEL WITH SPACE FOR LARGE FLAT SCREEN TV ABOVE
- $\overline{\langle \mathsf{G} \rangle}$ NEW KITCHEN COUNTERTOPS, CABINETS, AND APPLIANCES
- (H) EXISTING ENTRY STEPS TO REMAIN
- NEW LIFT AND SLIDE GLASS DOOR
- J 24" DEEP PLUNGE BATH
- K POCKET GLASS DOOR PARTITION WITH DOOR RECESS
- $\langle L \rangle$ dashed line indicates location of New Wood deck above
- M PRESSURE TREATED WOOD GUARD RAIL, 4X4 WOOD POSTS AND TAPERED TOP CAP
- N DASHED LINE INDICATES LOCATION OF SKYLIGHT ABOVE
- O DASHED LINE INDICATES LOCATION OF NEW ENTRY CANOPY ABOVE
- $\overline{\left\langle P\right\rangle }$ EXISTING CMU DEMISING WALL TO REMAIN
- $\langle \overline{\mathsf{Q}} \rangle$ SLIDING PARTITION WALL ENCLOSING HOME OFFICE
- $\stackrel{\textstyle \frown}{\mbox{R}}$ NEW WOOD FRAMED ROOF WITH SHAKE SHINGLES TO MATCH EXISTING. REFER TO ROOF PLAN FOR SLOPES
- S COMPOSITE WOOD DECK WITH PRESSURE TREATED 6X6 WOOD POSTS, REFER TO STRUCTURAL
- $\langle \mathsf{T} \rangle$ NOT USED
- (U) NEW WINDOW, REFER TO ELEVATIONS
- $\overline{\langle {
 m V} \rangle}$ NEW ENTRY DOOR WITH TEMPERED GLASS SIDE LITES
- W NEW STEEL STRUCTURAL COLUMN
- $\langle \overline{\chi} \rangle$ GLASS PARTITION WALL WITH GLASS DOOR
- $\overline{\langle \gamma \rangle}$ Gutter mounted to top of CMU wall
- Z NEW FIXED SKYLIGHT CURB MOUNTED TO ROOF SHEATHING
- EXISTING WOOD FRAMED ROOF WITH SHAKE SHINGLES TO REMAIN. PATCH AND REPAIR AS NEEDED
- BB EXISTING EXTERIOR STUCCO WALL FINISH TO REMAIN. PATCH AND REPAIR AS NEEDED
- ALL EXISTING MECHANICAL, ELECTRICAL AND PLUMBING SYSTEMS TO REMAIN WHERE APPLICABLE. GENERAL CONTRACTOR TO FIELD VERIFY CURRENT CONDITION AND OPERABILITY PRIOR TO CONDUCTING ANY FINISH WORK.

HATCHED AREA NOT IN SCOPE OF WORK





Issue:	Date:	Ву:
PRICING SET	09/11/23	SMD
PRICING SET-VE REVISION	10/26/23	SMD
REVIEW SET	11/29/23	SMD



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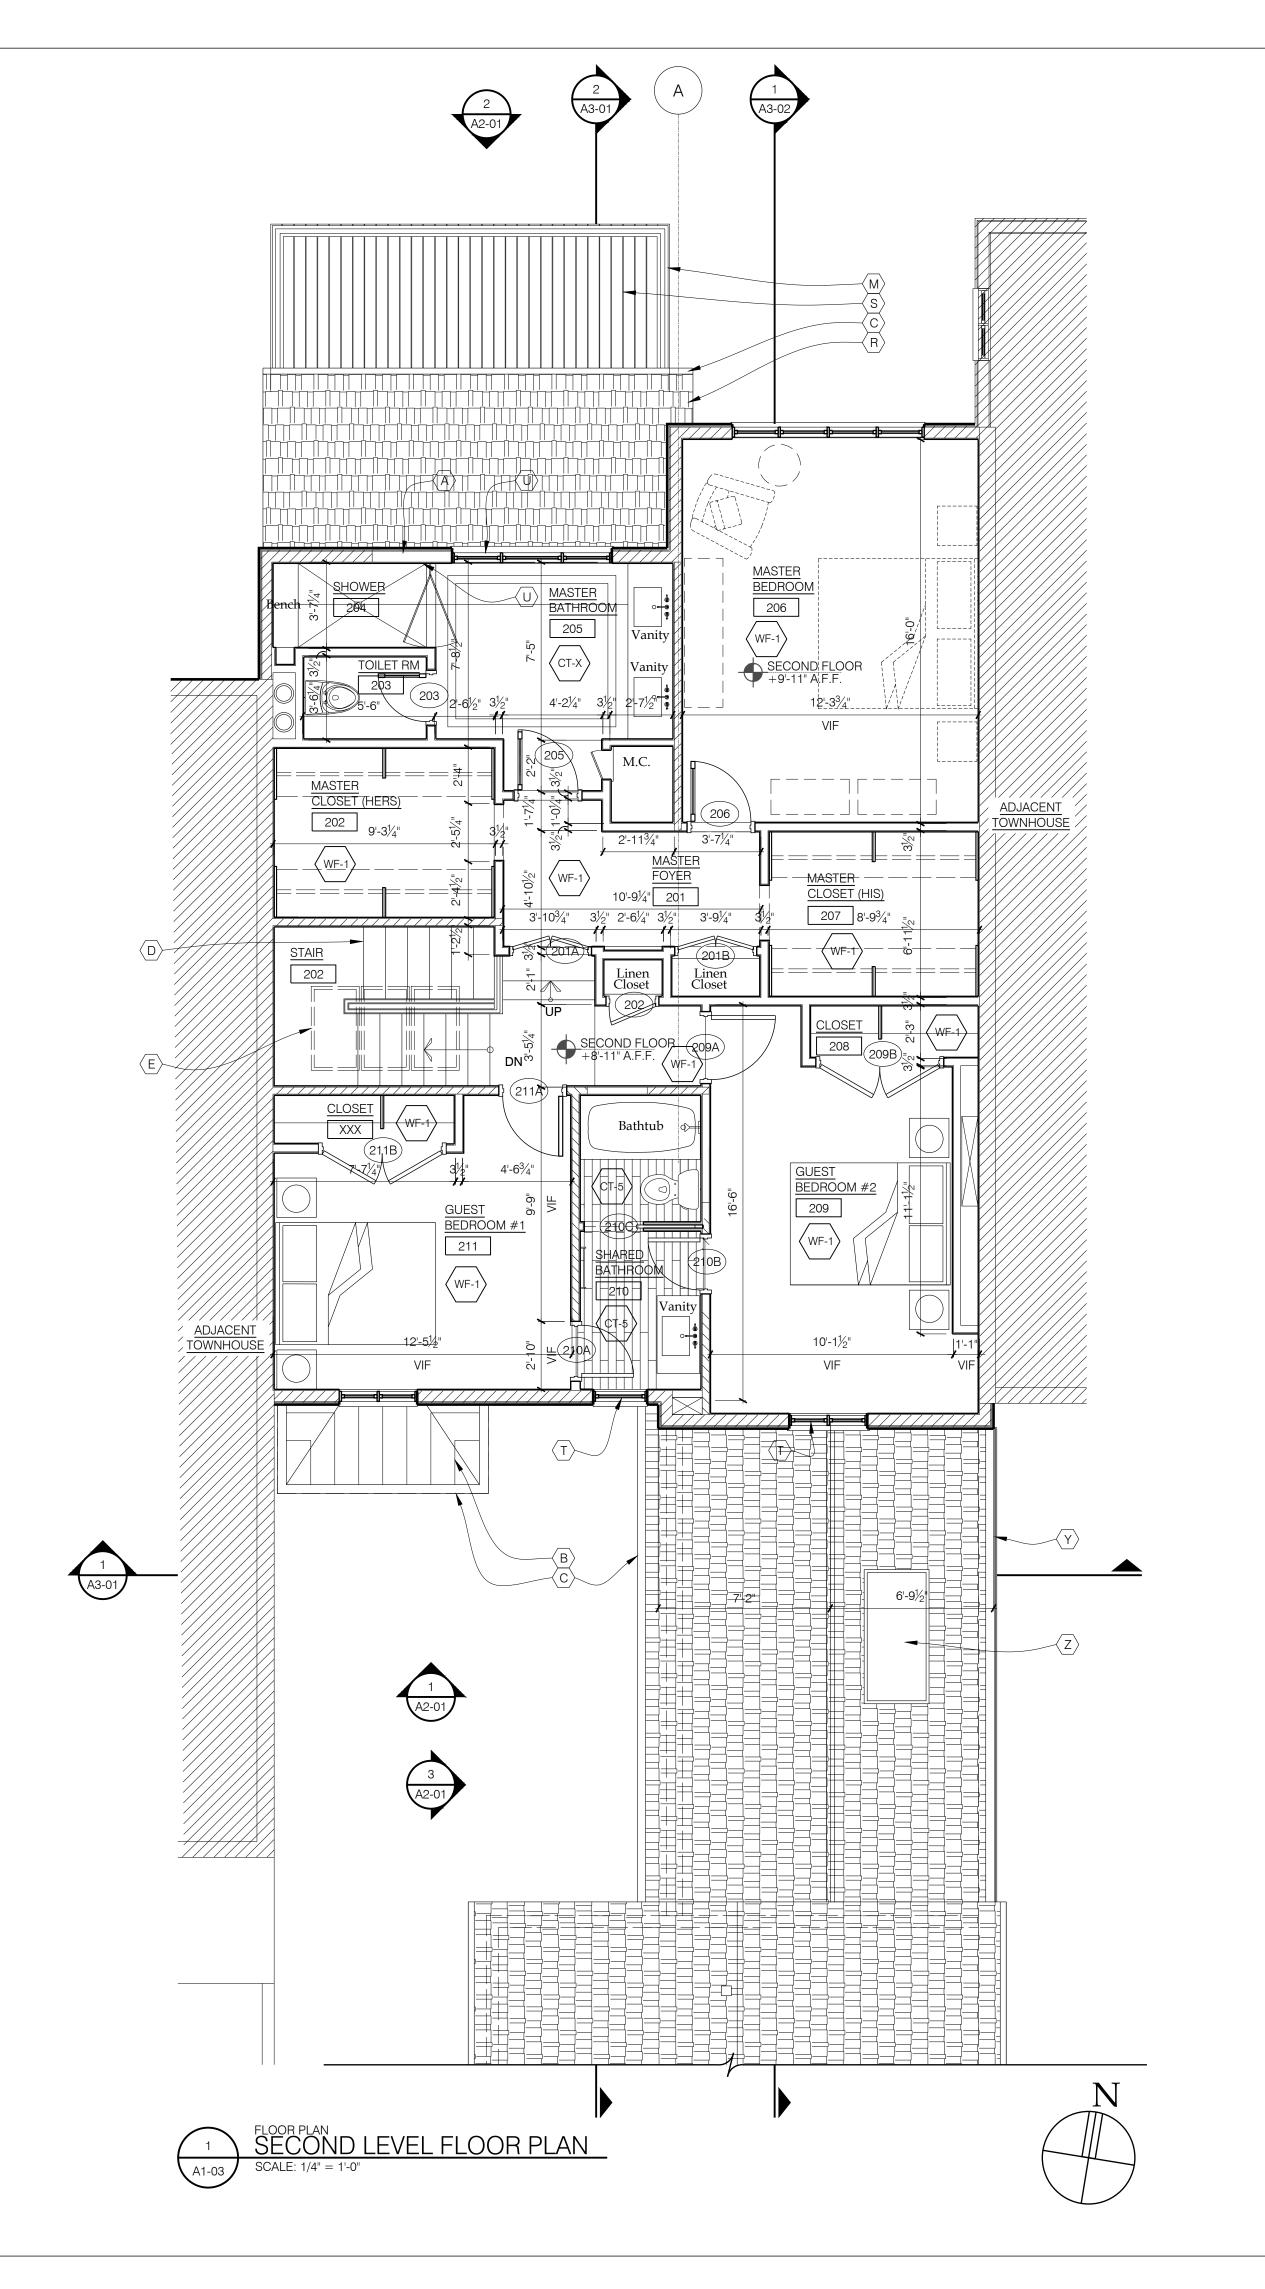
Kevin and Carol Ryan
Townhouse Renovation

32 Hidden Valley Dr Rocky River, OH, 44116

FIRST LEVEL FLOOR PLAN

Date	Project Number	
11/29/2023	23-054	
Drawn by	Drawing Number	
JTK/ AND/ KH		
Checked by	۸ ۸	\sim

SMD/AND



- I. GENERAL CONTRACTOR & ALL SUBCONTRACTORS TO FIELD VERIFY ALL EXISTING CONDITIONS, EXAMINE THE ENTIRE SITE AND THE CONSTRCTION DOCUMENTS TO ENSURE THEIR KNOWLEDGE OF ALL RELEVANT EXISTING FIELD CONDITIONS AFFECTING THE SCOPE OF WORK PRIOR TO PRICING. ANY DESCREPANCIES OR CONFLICTS BETWEEN THE ARCHITECTURAL AND ENGINEERING DOCUMENTS AND FIELD CONDITIONS SHALL BE CLARIFIED WITH THE ARCHITECT AND ENGINEER BEFORE INITIATING WORK.
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- 5. ALL DOOR ROUGH OPENINGS ARE TO BE LOCATED 3" FROM NEAREST WALL AT HINGE SIDE (TYPICAL UNLESS OTHERWISE NOTED).

NEW CONSTRUCTION KEYN O T E S :

- $\overline{\langle \mathsf{A} \rangle}$ EXTERIOR WALL INFILL TO MATCH EXISTING.
- B NEW WOOD FRAMED ENTRY CANOPY WITH STANDING SEAM METAL ROOF AND FLANKING WOOD SUPPORT BRACKETS
- $\langle C \rangle$ NEW GUTTERS AND DOWNSPOUTS
- (D) OPEN TREAD OAK STAIR CASE WITH GLASS RAILINGS AND METAL HANDRAIL
- (E) EXISTING SKYLIGHT TO REMAIN
- F NEW GAS INSERT FIRE PLACE AND MANTEL WITH SPACE FOR LARGE FLAT SCREEN TV ABOVE
- G NEW KITCHEN COUNTERTOPS, CABINETS, AND APPLIANCES
- (H) EXISTING ENTRY STEPS TO REMAIN
- (I) NEW SLIDING GLASS DOOR
- J 24" DEEP PLUNGE BATH
- K POCKET GLASS DOOR PARTITION WITH DOOR RECESS
- $\langle \mathsf{L}
 angle$ dashed line indicates location of New Wood deck above
- M PRESSURE TREATED WOOD GUARD RAIL, 4X4 WOOD POSTS AND TAPERED TOP CAP
- N DASHED LINE INDICATES LOCATION OF SKYLIGHT ABOVE
- O DASHED LINE INDICATES LOCATION OF NEW ENTRY CANOPY ABOVE
- P EXISTING CMU DEMISING WALL TO REMAIN
- $igspace{\mathbb{Q}}$ SLIDING PARTITION WALL ENCLOSING HOME OFFICE
- $\begin{tabular}{ll} \begin{tabular}{ll} \beg$
- S COMPOSITE WOOD DECK WITH PRESSURE TREATED 6X6 WOOD POSTS, REFER TO STRUCTURAL
- T EXISTING WINDOW/ DOOR, SILL, AND ASSOCIATED TRIM TO REMAIN. PATCH AND REPAIR MILL WORK AS NEEDED.
- $\overline{\left(\mathsf{U} \right)}$ NEW WINDOW, REFER TO ELEVATIONS
- $\langle {
 m V}
 angle$ new entry door with tempered glass side lites
- W NEW STEEL STRUCTURAL COLUMN
- X GLASS PARTITION WALL WITH GLASS DOOR
- Y GUTTER MOUNTED TO TOP OF CMU WALL
- Z NEW FIXED SKYLIGHT CURB MOUNTED TO ROOF SHEATHING
- (AA) EXISTING WOOD FRAMED ROOF WITH SHAKE SHINGLES TO REMAIN. PATCH AND REPAIR AS NEEDED
- (BB) EXISTING EXTERIOR STUCCO WALL FINISH TO REMAIN. PATCH AND REPAIR AS NEEDED
- ALL EXISTING MECHANICAL, ELECTRICAL AND PLUMBING SYSTEMS TO REMAIN WHERE APPLICABLE. GENERAL CONTRACTOR TO FIELD VERIFY CURRENT CONDITION AND OPERABILITY PRIOR TO CONDUCTING ANY FINISH WORK.





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PRICING SET	09/11/23	SMD
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REVIEW SET	11/29/23	SMD



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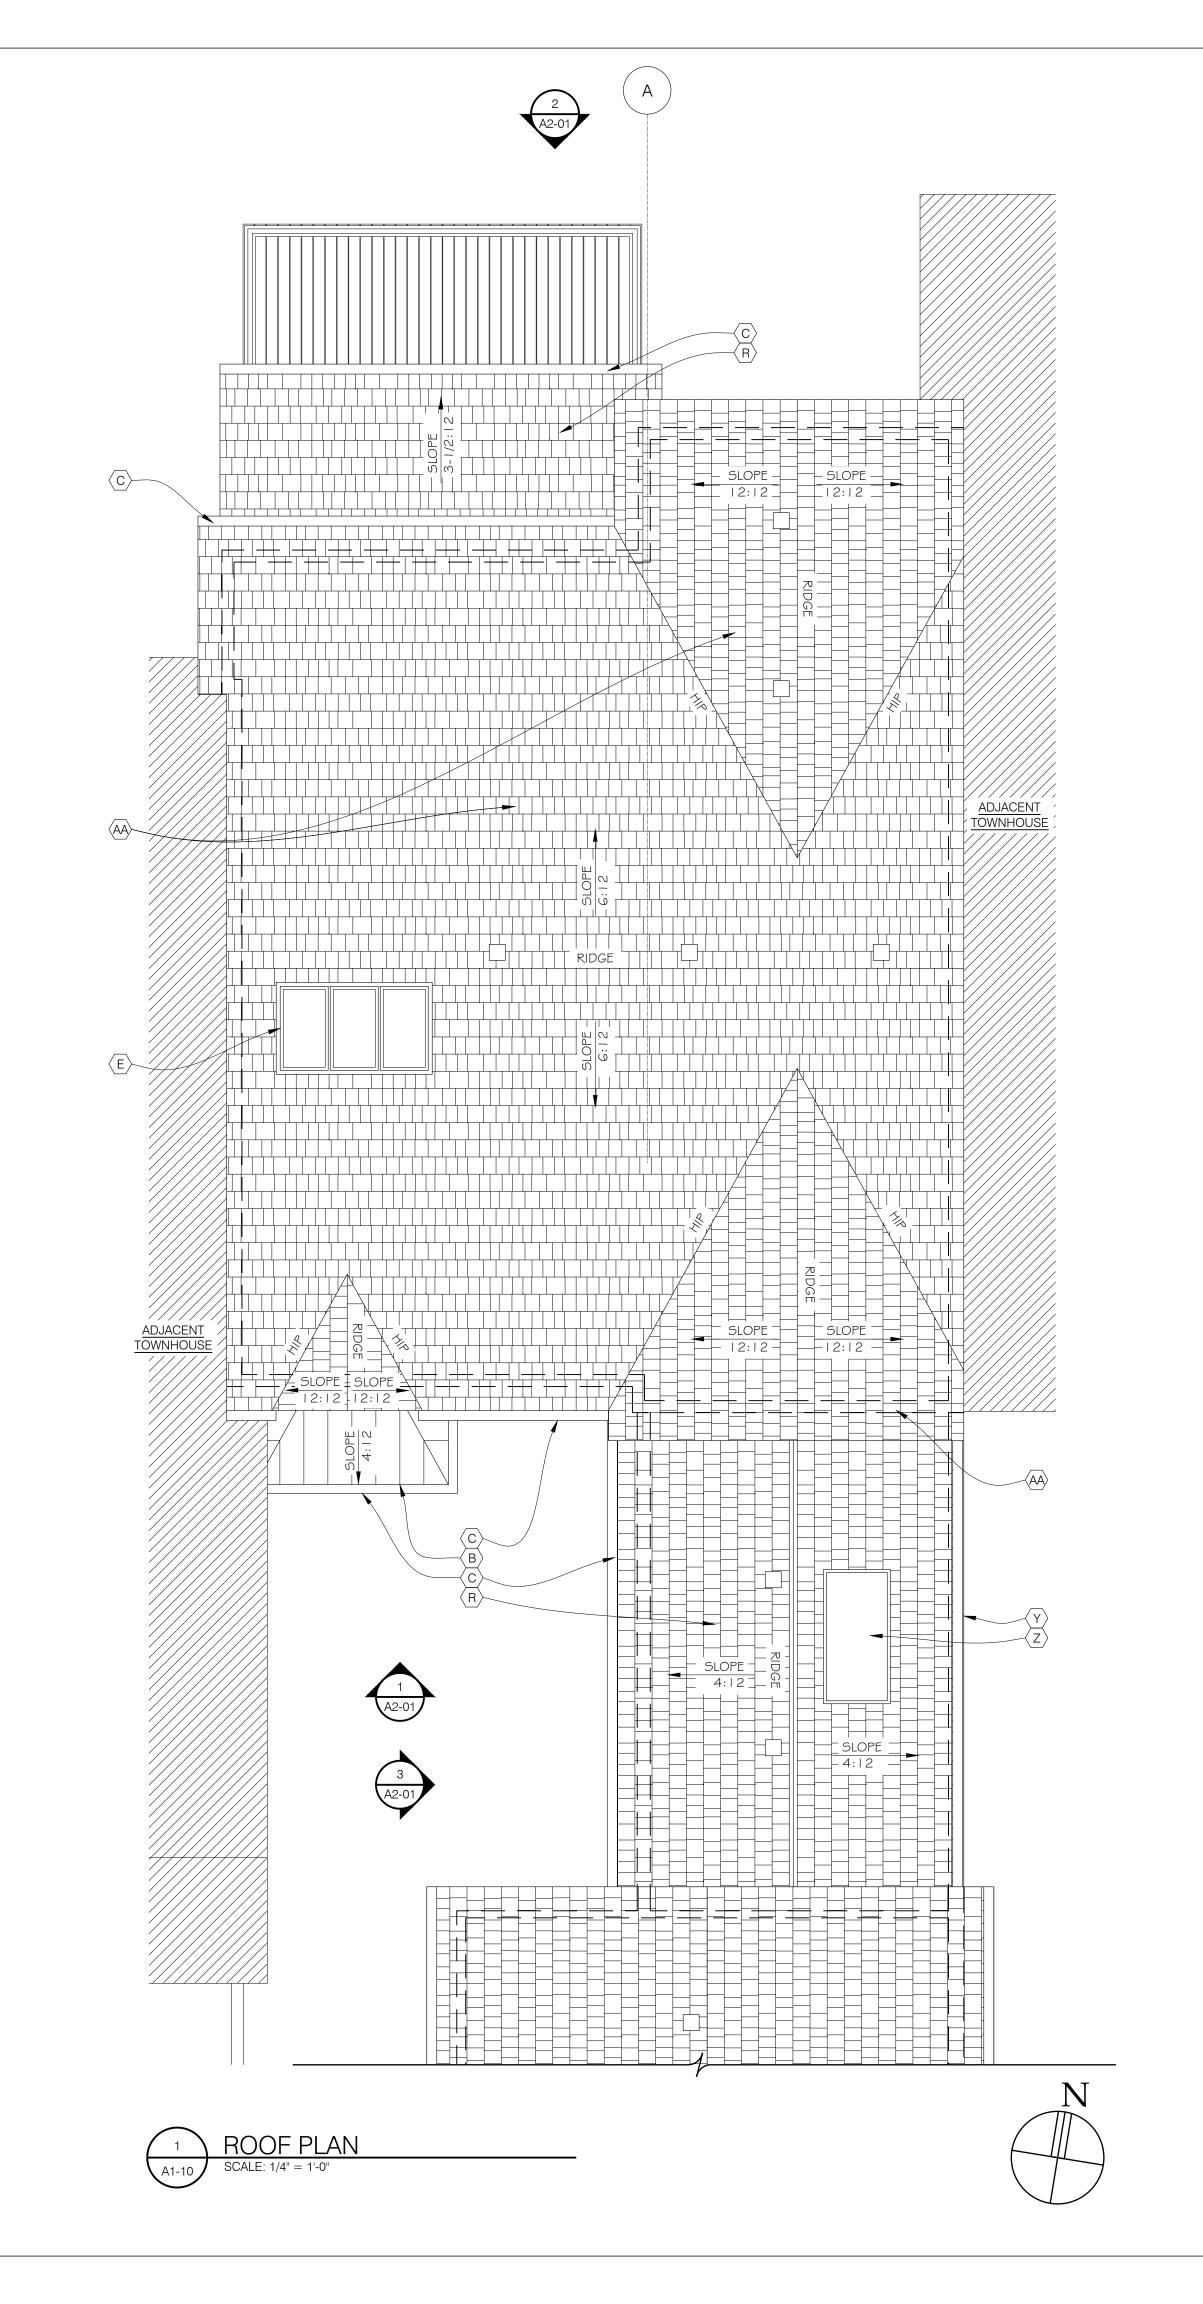
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Townhouse Renovation

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SECOND LEVEL FLOOR PLAN

Date	Project Number	
11/29/2023	23-054	
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Drawn by	Drawing Number	
JTK/ AND/ KH		
Checked by	\ \ \ \ \ \ \	\cap

SMD/AND



- GENERAL CONTRACTOR \$ ALL SUBCONTRACTORS TO FIELD VERIFY ALL EXISTING CONDITIONS, EXAMINE THE ENTIRE SITE AND THE CONSTRCTION DOCUMENTS TO ENSURE THEIR KNOWLEDGE OF ALL RELEVANT EXISTING FIELD CONDITIONS AFFECTING THE SCOPE OF WORK PRIOR TO PRICING. ANY DESCREPANCIES OR CONFLICTS BETWEEN THE ARCHITECTURAL AND ENGINEERING DOCUMENTS AND FIELD CONDITIONS SHALL BE CLARIFIED WITH THE ARCHITECT AND ENGINEER BEFORE INITIATING WORK.
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NEW CONSTRUCTION KEYN O T E S:

- $\langle A \rangle$ EXTERIOR WALL INFILL TO MATCH EXISTING.
- (B) NEW WOOD FRAMED ENTRY CANOPY WITH STANDING SEAM METAL ROOF AND FLANKING WOOD SUPPORT BRACKETS
- (C) NEW GUTTERS AND DOWNSPOUTS
- $\langle \mathsf{D}
 angle$ OPEN TREAD OAK STAIR CASE WITH GLASS RAILINGS AND METAL HANDRAIL
- $\langle \mathsf{E}
 angle$ Existing skylight to remain
- $\langle \mathsf{F}
 angle$ new gas insert fire place and mantel with space for large flat SCREEN TV ABOVE
- (G) NEW KITCHEN COUNTERTOPS, CABINETS, AND APPLIANCES
- (H) EXISTING ENTRY STEPS TO REMAIN
- NEW SLIDING GLASS DOOR
- $\langle J \rangle$ 24" DEEP PLUNGE BATH
- $\langle \mathsf{K}
 angle$ pocket glass door partition with door recess
- \langle Langle dashed line indicates location of New Wood deck above
- M PRESSURE TREATED WOOD GUARD RAIL, 4X4 WOOD POSTS AND TAPERED
- $\langle \mathsf{N}
 angle$ dashed line indicates location of skylight above
- O DASHED LINE INDICATES LOCATION OF NEW ENTRY CANOPY ABOVE
- P EXISTING CMU DEMISING WALL TO REMAIN
- $\langle \overline{\mathsf{Q}} \rangle$ SLIDING PARTITION WALL ENCLOSING HOME OFFICE
- R NEW WOOD FRAMED ROOF WITH SHAKE SHINGLES TO MATCH EXISTING. REFER TO ROOF PLAN FOR SLOPES
- (S) COMPOSITE WOOD DECK WITH PRESSURE TREATED 6X6 WOOD POSTS, REFER TO STRUCTURAL
- $\langle \mathsf{T} \rangle$ EXISTING WINDOW/ DOOR, SILL, AND ASSOCIATED TRIM TO REMAIN. PATCH AND REPAIR MILL WORK AS NEEDED.
- (U) NEW WINDOW, REFER TO ELEVATIONS
- \langle V \rangle NEW ENTRY DOOR WITH TEMPERED GLASS SIDE LITES
- W NEW STEEL STRUCTURAL COLUMN
- $\langle \chi \rangle$ GLASS PARTITION WALL WITH GLASS DOOR
- $\langle \overline{\mathsf{Y}} \rangle$ Gutter mounted to top of cmu wall
- $\langle z \rangle$ NEW FIXED SKYLIGHT CURB MOUNTED TO ROOF SHEATHING
- (AA) EXISTING WOOD FRAMED ROOF WITH SHAKE SHINGLES TO REMAIN. PATCH AND REPAIR AS NEEDED
- (BB) EXISTING EXTERIOR STUCCO WALL FINISH TO REMAIN. PATCH AND REPAIR AS
- ALL EXISTING MECHANICAL, ELECTRICAL AND PLUMBING SYSTEMS TO REMAIN WHERE APPLICABLE. GENERAL CONTRACTOR TO FIELD VERIFY CURRENT CONDITION AND OPERABILITY PRIOR TO CONDUCTING ANY FINISH WORK.

HATCHED AREA NOT IN SCOPE OF WORK





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ROOF PLAN


11/29/2023 23-054 JTK/ AND/ KH

SMD/AND SMD/AND

EXTERIC	OR MATERIAL SCHEDULE	- RYAN RESID	ENCE		
DESIGNATION:	MATERIAL:	MANUFACTURER:	TYPE/STYLE:	COLOR:	NOTES:
RF-I	SHAKE ROOFING	TBD	LAP	TO MATCH EXISTING	OR APPROVED EQUIV.
RF-2	METAL ROOF	PAC-CLAD	STANDING SEAM	MIDNIGHT BRONZE	TO MATCH EXISTING
ST-I	STUCCO	STO	SMOOTH FINISH	CLOUD	TO MATCH EXISTING
PT-I	PAINT	SHERWIN WILLIAMS	EXTERIOR GRADE FINISH	TO MATCH EXISTING TRIM	
BR-I	FACE BRICK	GLEN GEARY	FULL DEPTH	FRENCH PROVINCIAL HANDMADE	
GL- I	WOOD WINDOWS	PELLA	CASEMENT, FIXED, SLIDING DOOR	BLACK	"LIFESTYLE" SERIES (TO MATCH EXISTING)
GL-2	SKYLIGHT	VELUX	FIXED, CURB MOUNT	TO MATCH WINDOWS	

RF-I) SHAKE ROOFING

GL-I) CASEMENT WOOD WINDOWS

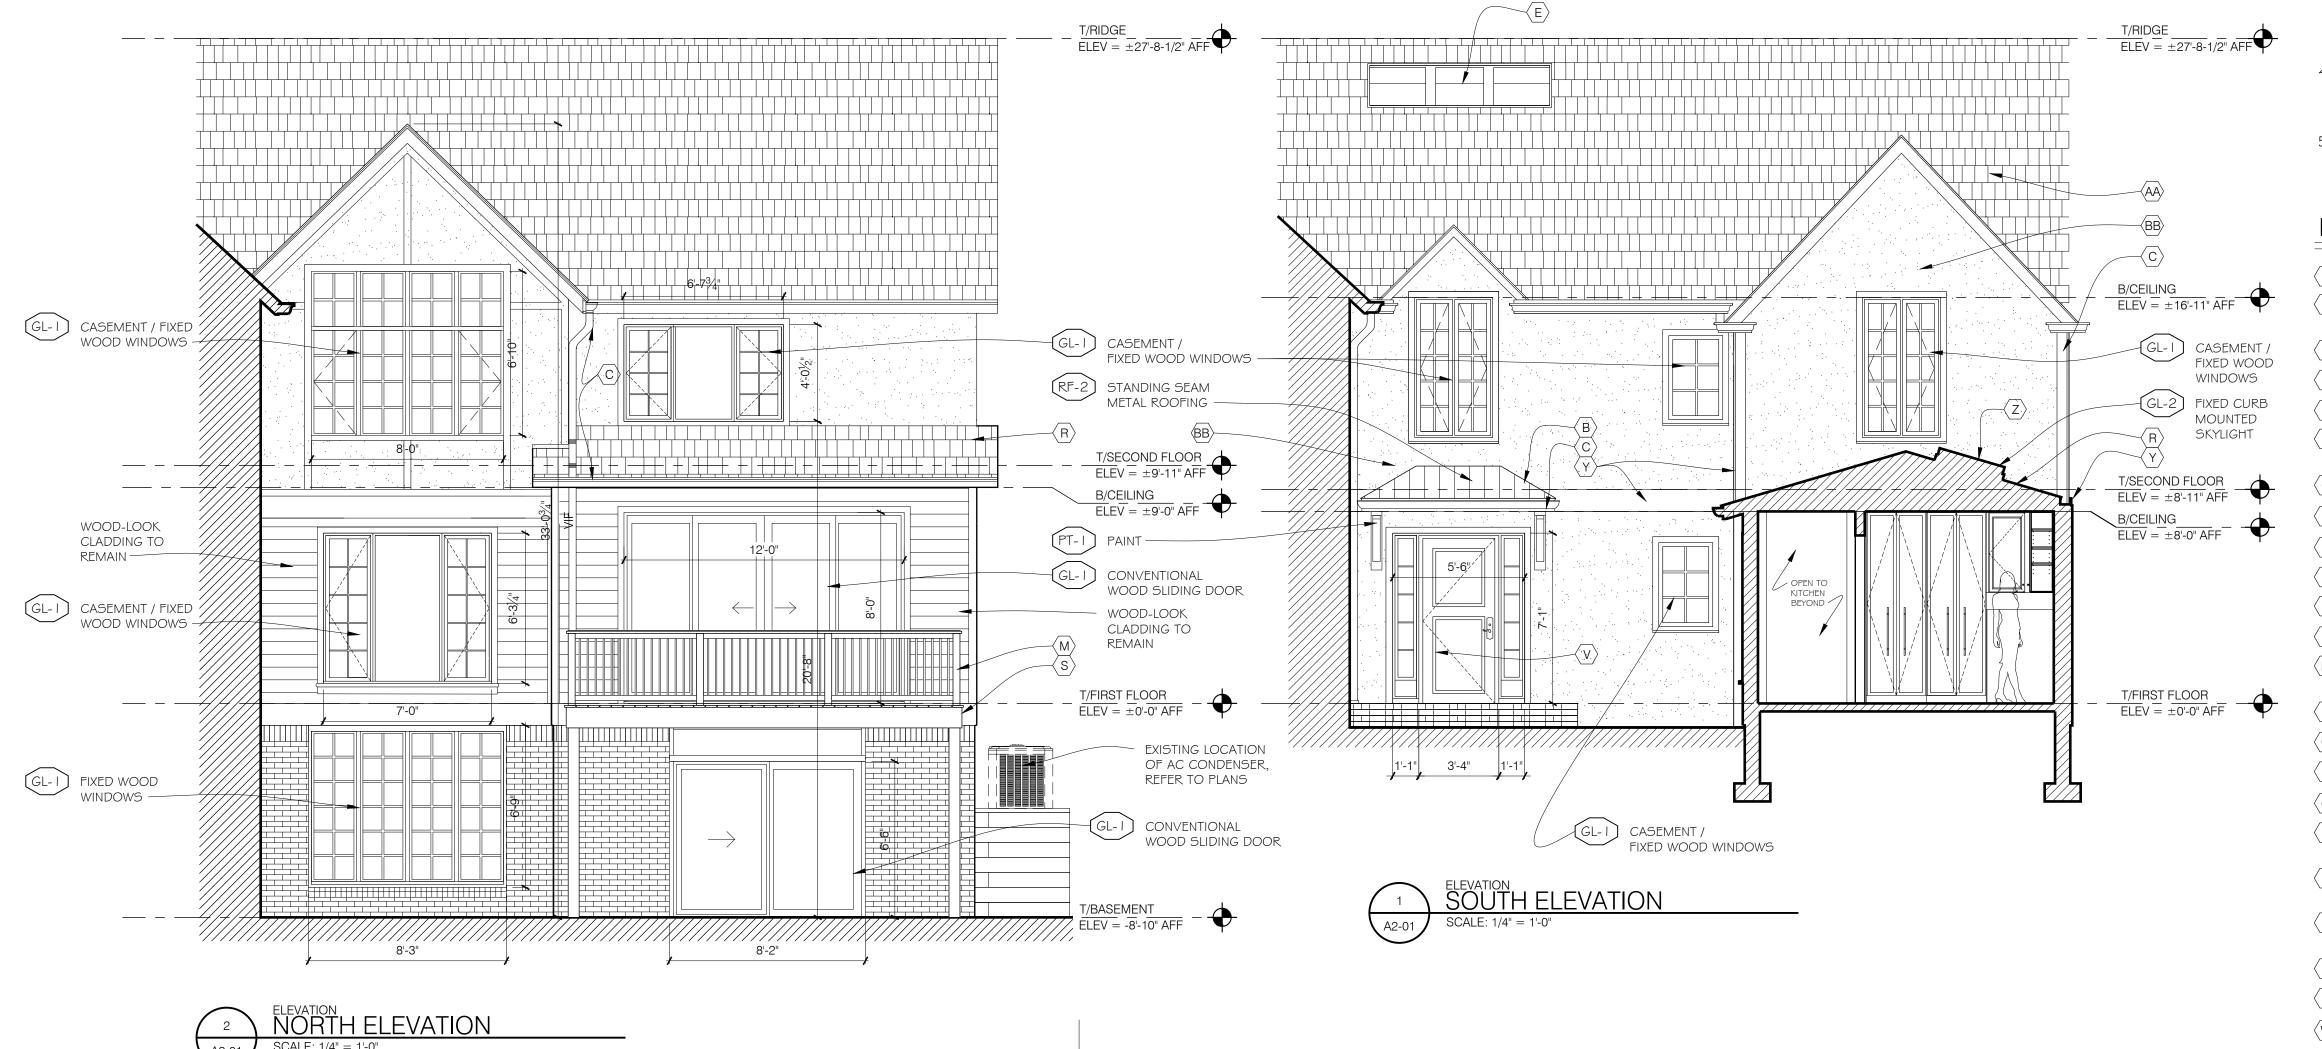


GENERAL NOTES:

- GENERAL CONTRACTOR \$ ALL SUBCONTRACTORS TO FIELD VERIFY ALL EXISTING CONDITIONS, EXAMINE THE ENTIRE SITE AND THE CONSTRCTION DOCUMENTS TO ENSURE THEIR KNOWLEDGE OF ALL RELEVANT EXISTING FIELD CONDITIONS AFFECTING THE SCOPE OF WORK PRIOR TO PRICING. ANY DESCREPANCIES OR CONFLICTS BETWEEN THE ARCHITECTURAL AND ENGINEERING DOCUMENTS AND FIELD CONDITIONS SHALL BE CLARIFIED WITH THE ARCHITECT AND ENGINEER BEFORE INITIATING WORK.
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NEW CONSTRUCTION KEYN O T E S :

- (A) EXTERIOR WALL INFILL TO MATCH EXISTING.
- (B) NEW WOOD FRAMED ENTRY CANOPY WITH STANDING SEAM METAL ROOF AND FLANKING WOOD SUPPORT BRACKETS
- C NEW GUTTERS AND DOWNSPOUTS
- D OPEN TREAD OAK STAIR CASE WITH GLASS RAILINGS AND METAL HANDRAIL
- (E) EXISTING SKYLIGHT TO REMAIN
- F NEW GAS INSERT FIRE PLACE AND MANTEL WITH SPACE FOR LARGE FLAT SCREEN TV ABOVE
- G NEW KITCHEN COUNTERTOPS, CABINETS, AND APPLIANCES
- (H) EXISTING ENTRY STEPS TO REMAIN
- NEW SLIDING GLASS DOOR
- J 24" DEEP PLUNGE BATH
- K POCKET GLASS DOOR PARTITION WITH DOOR RECESS
- (L) DASHED LINE INDICATES LOCATION OF NEW WOOD DECK ABOVE
- M PRESSURE TREATED WOOD GUARD RAIL, 4X4 WOOD POSTS AND TAPERED
- N DASHED LINE INDICATES LOCATION OF SKYLIGHT ABOVE
- $\langle \mathsf{O}
 angle$ dashed line indicates location of New Entry canopy above
- (P) EXISTING CMU DEMISING WALL TO REMAIN
- $\langle Q \rangle$ SLIDING PARTITION WALL ENCLOSING HOME OFFICE
- REFER TO ROOF PLAN FOR SLOPES

 NEW WOOD FRAMED ROOF WITH SHAKE SHINGLES TO MATCH EXISTING.
- S COMPOSITE WOOD DECK WITH PRESSURE TREATED 6X6 WOOD POSTS, REFER TO STRUCTURAL
- T EXISTING WINDOW/ DOOR, SILL, AND ASSOCIATED TRIM TO REMAIN. PATCH AND REPAIR MILL WORK AS NEEDED.
- (U) NEW WINDOW, REFER TO ELEVATIONS
- $\langle V \rangle$ NEW ENTRY DOOR WITH TEMPERED GLASS SIDE LITES
- W NEW STEEL STRUCTURAL COLUMN
- $\langle \chi \rangle$ GLASS PARTITION WALL WITH GLASS DOOR
- $\langle \overline{Y} \rangle$ GUTTER MOUNTED TO TOP OF CMU WALL
- (AA) EXISTING WOOD FRAMED ROOF WITH SHAKE SHINGLES TO REMAIN. PATCH
- (CC) ALL EXISTING MECHANICAL, ELECTRICAL AND PLUMBING SYSTEMS TO REMAIN WHERE APPLICABLE. GENERAL CONTRACTOR TO FIELD VERIFY CURRENT



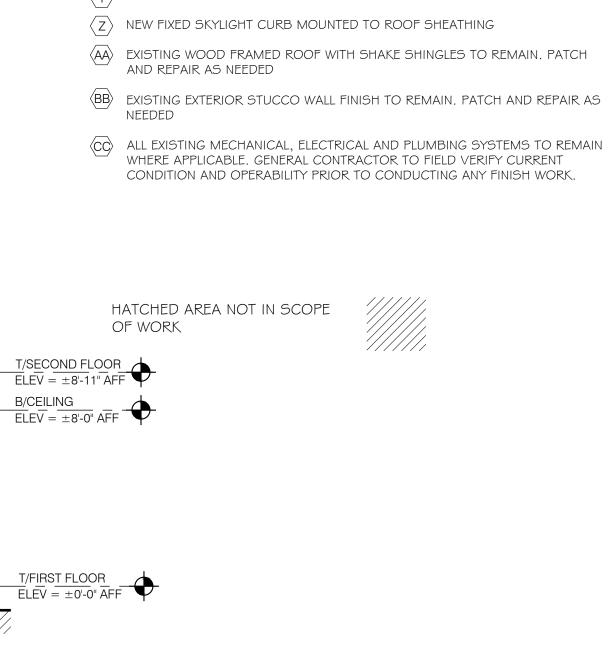

Issue:	Date:	Ву:
PRICING SET	09/11/23	SMD
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REVIEW SET	11/29/23	SMD

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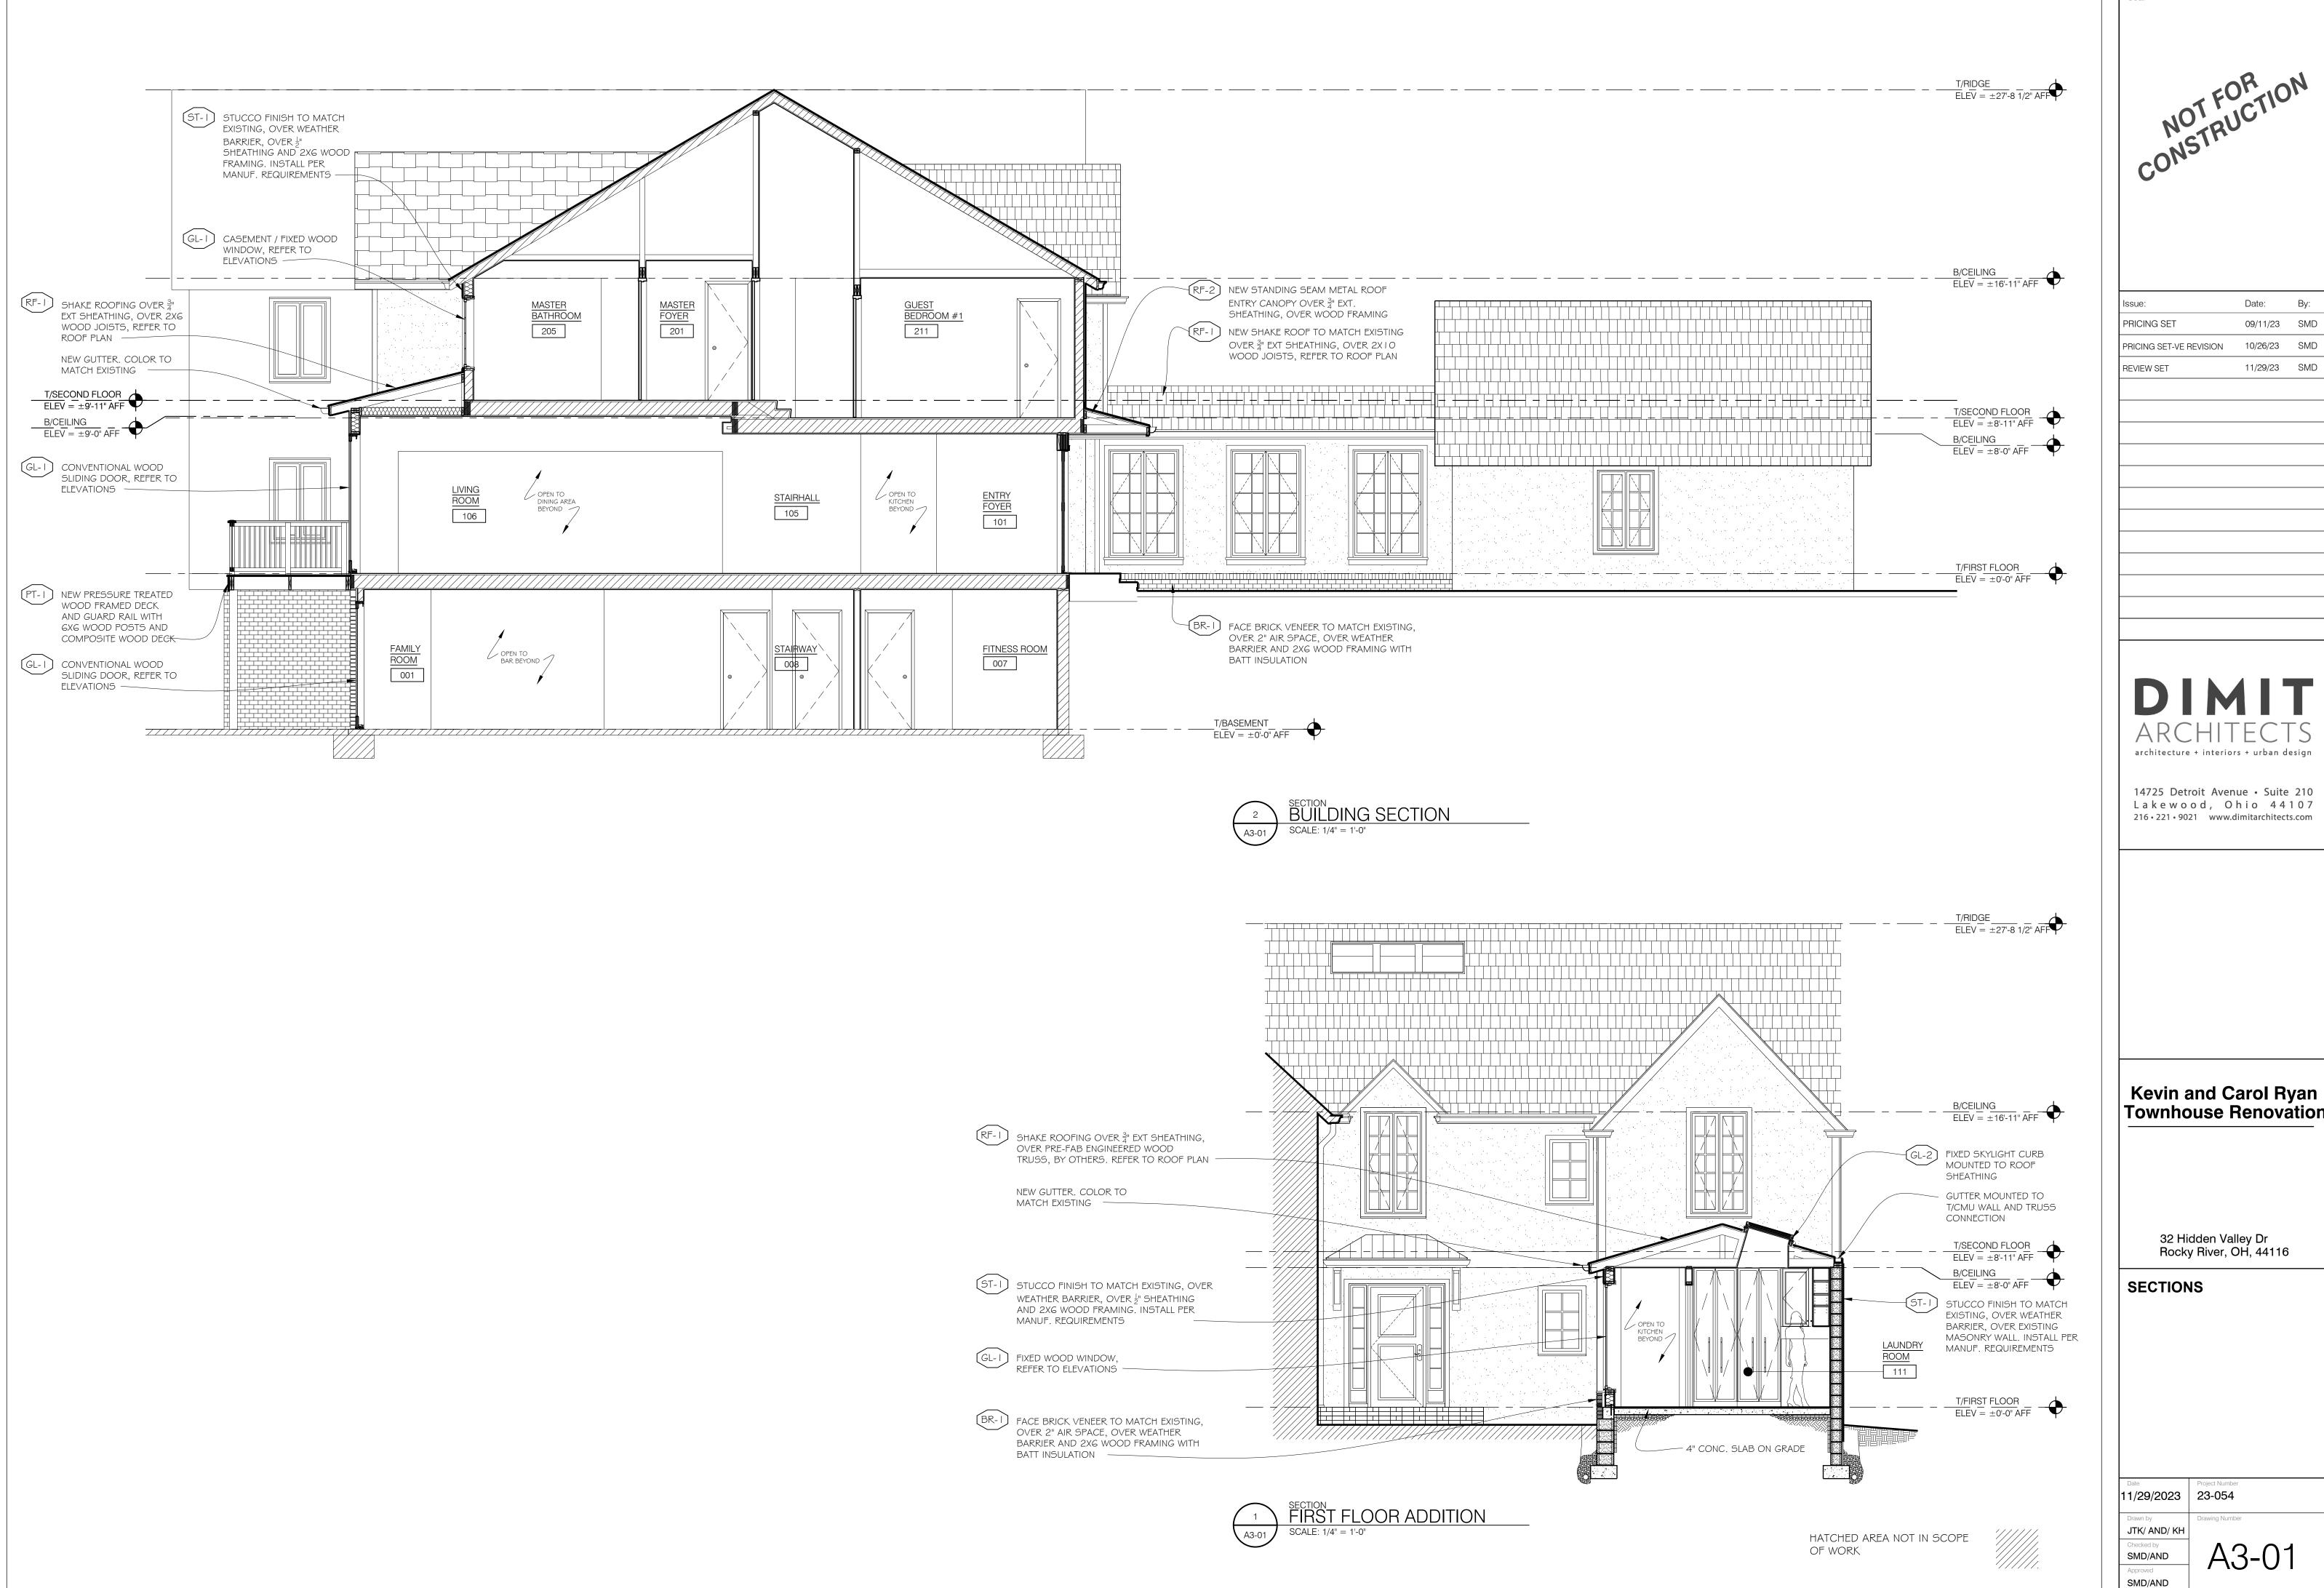
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EXTERIOR ELEVATIONS

Date	Project Number
11/29/2023	23-054
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Drawn by	Drawing Number
JTK/ AND/ KH	
Checked by	$\Lambda \cap \cap \Lambda$
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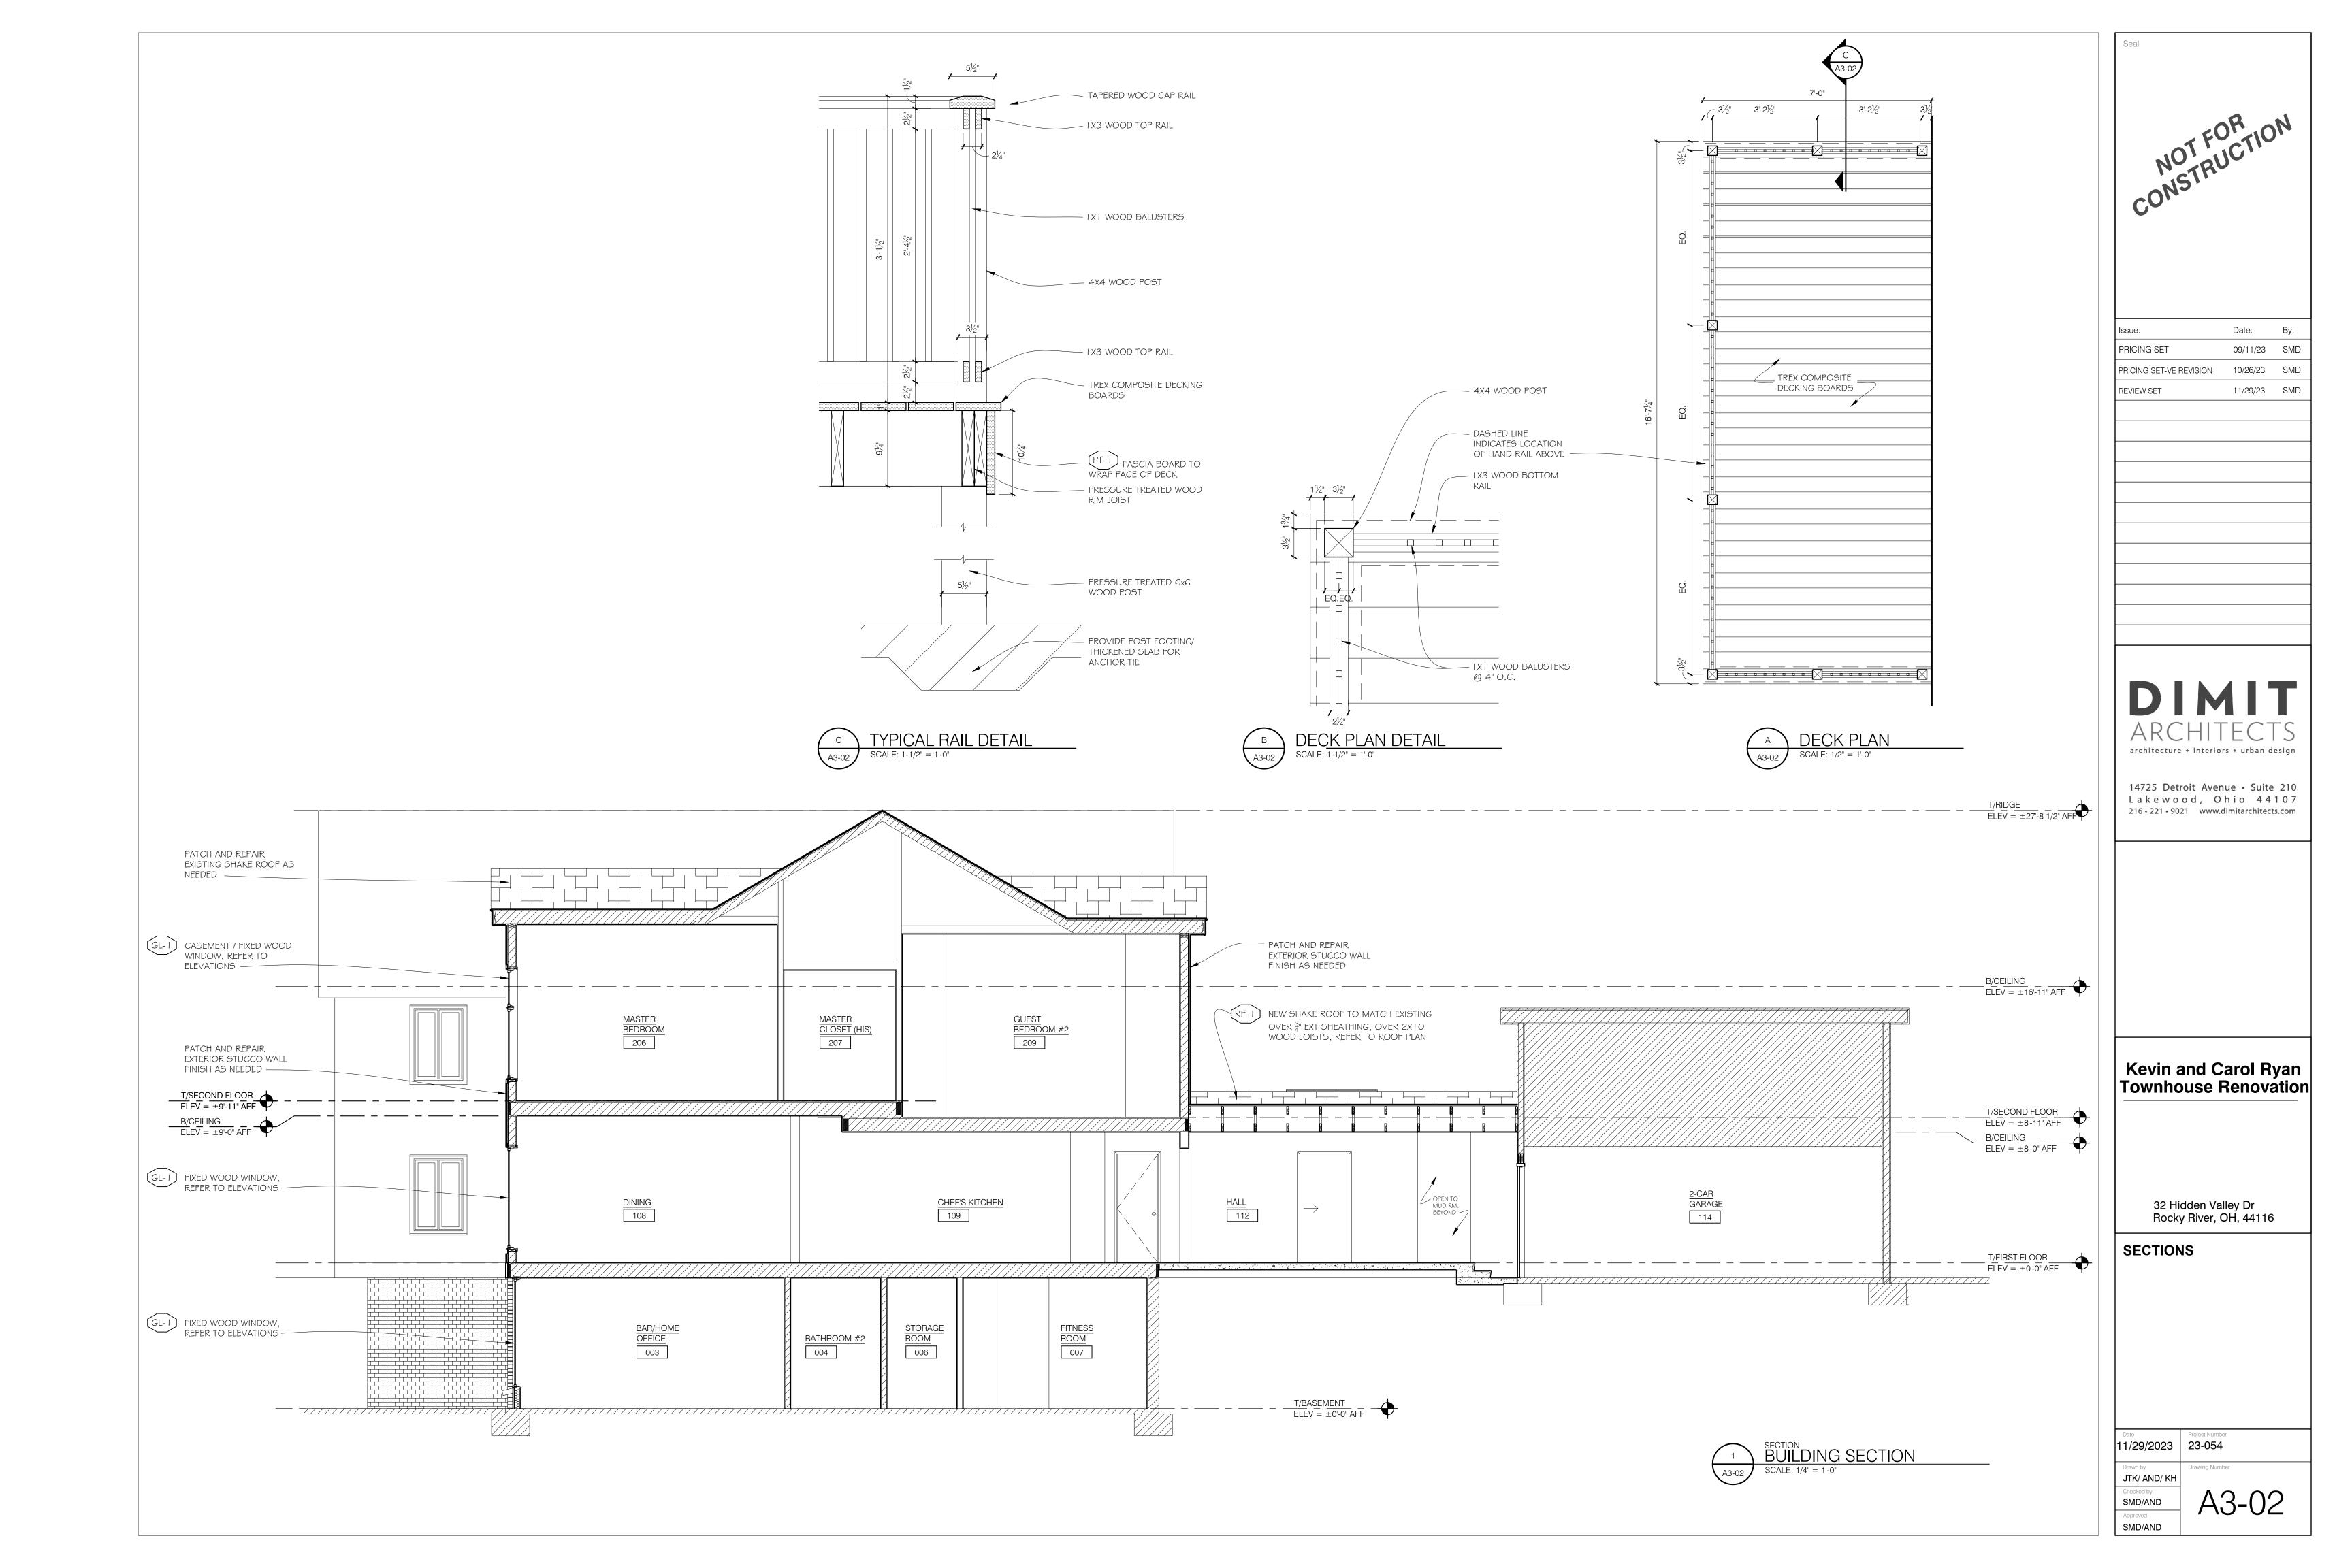



Issue:	Date:	Ву:
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REVIEW SET	11/29/23	SMD	

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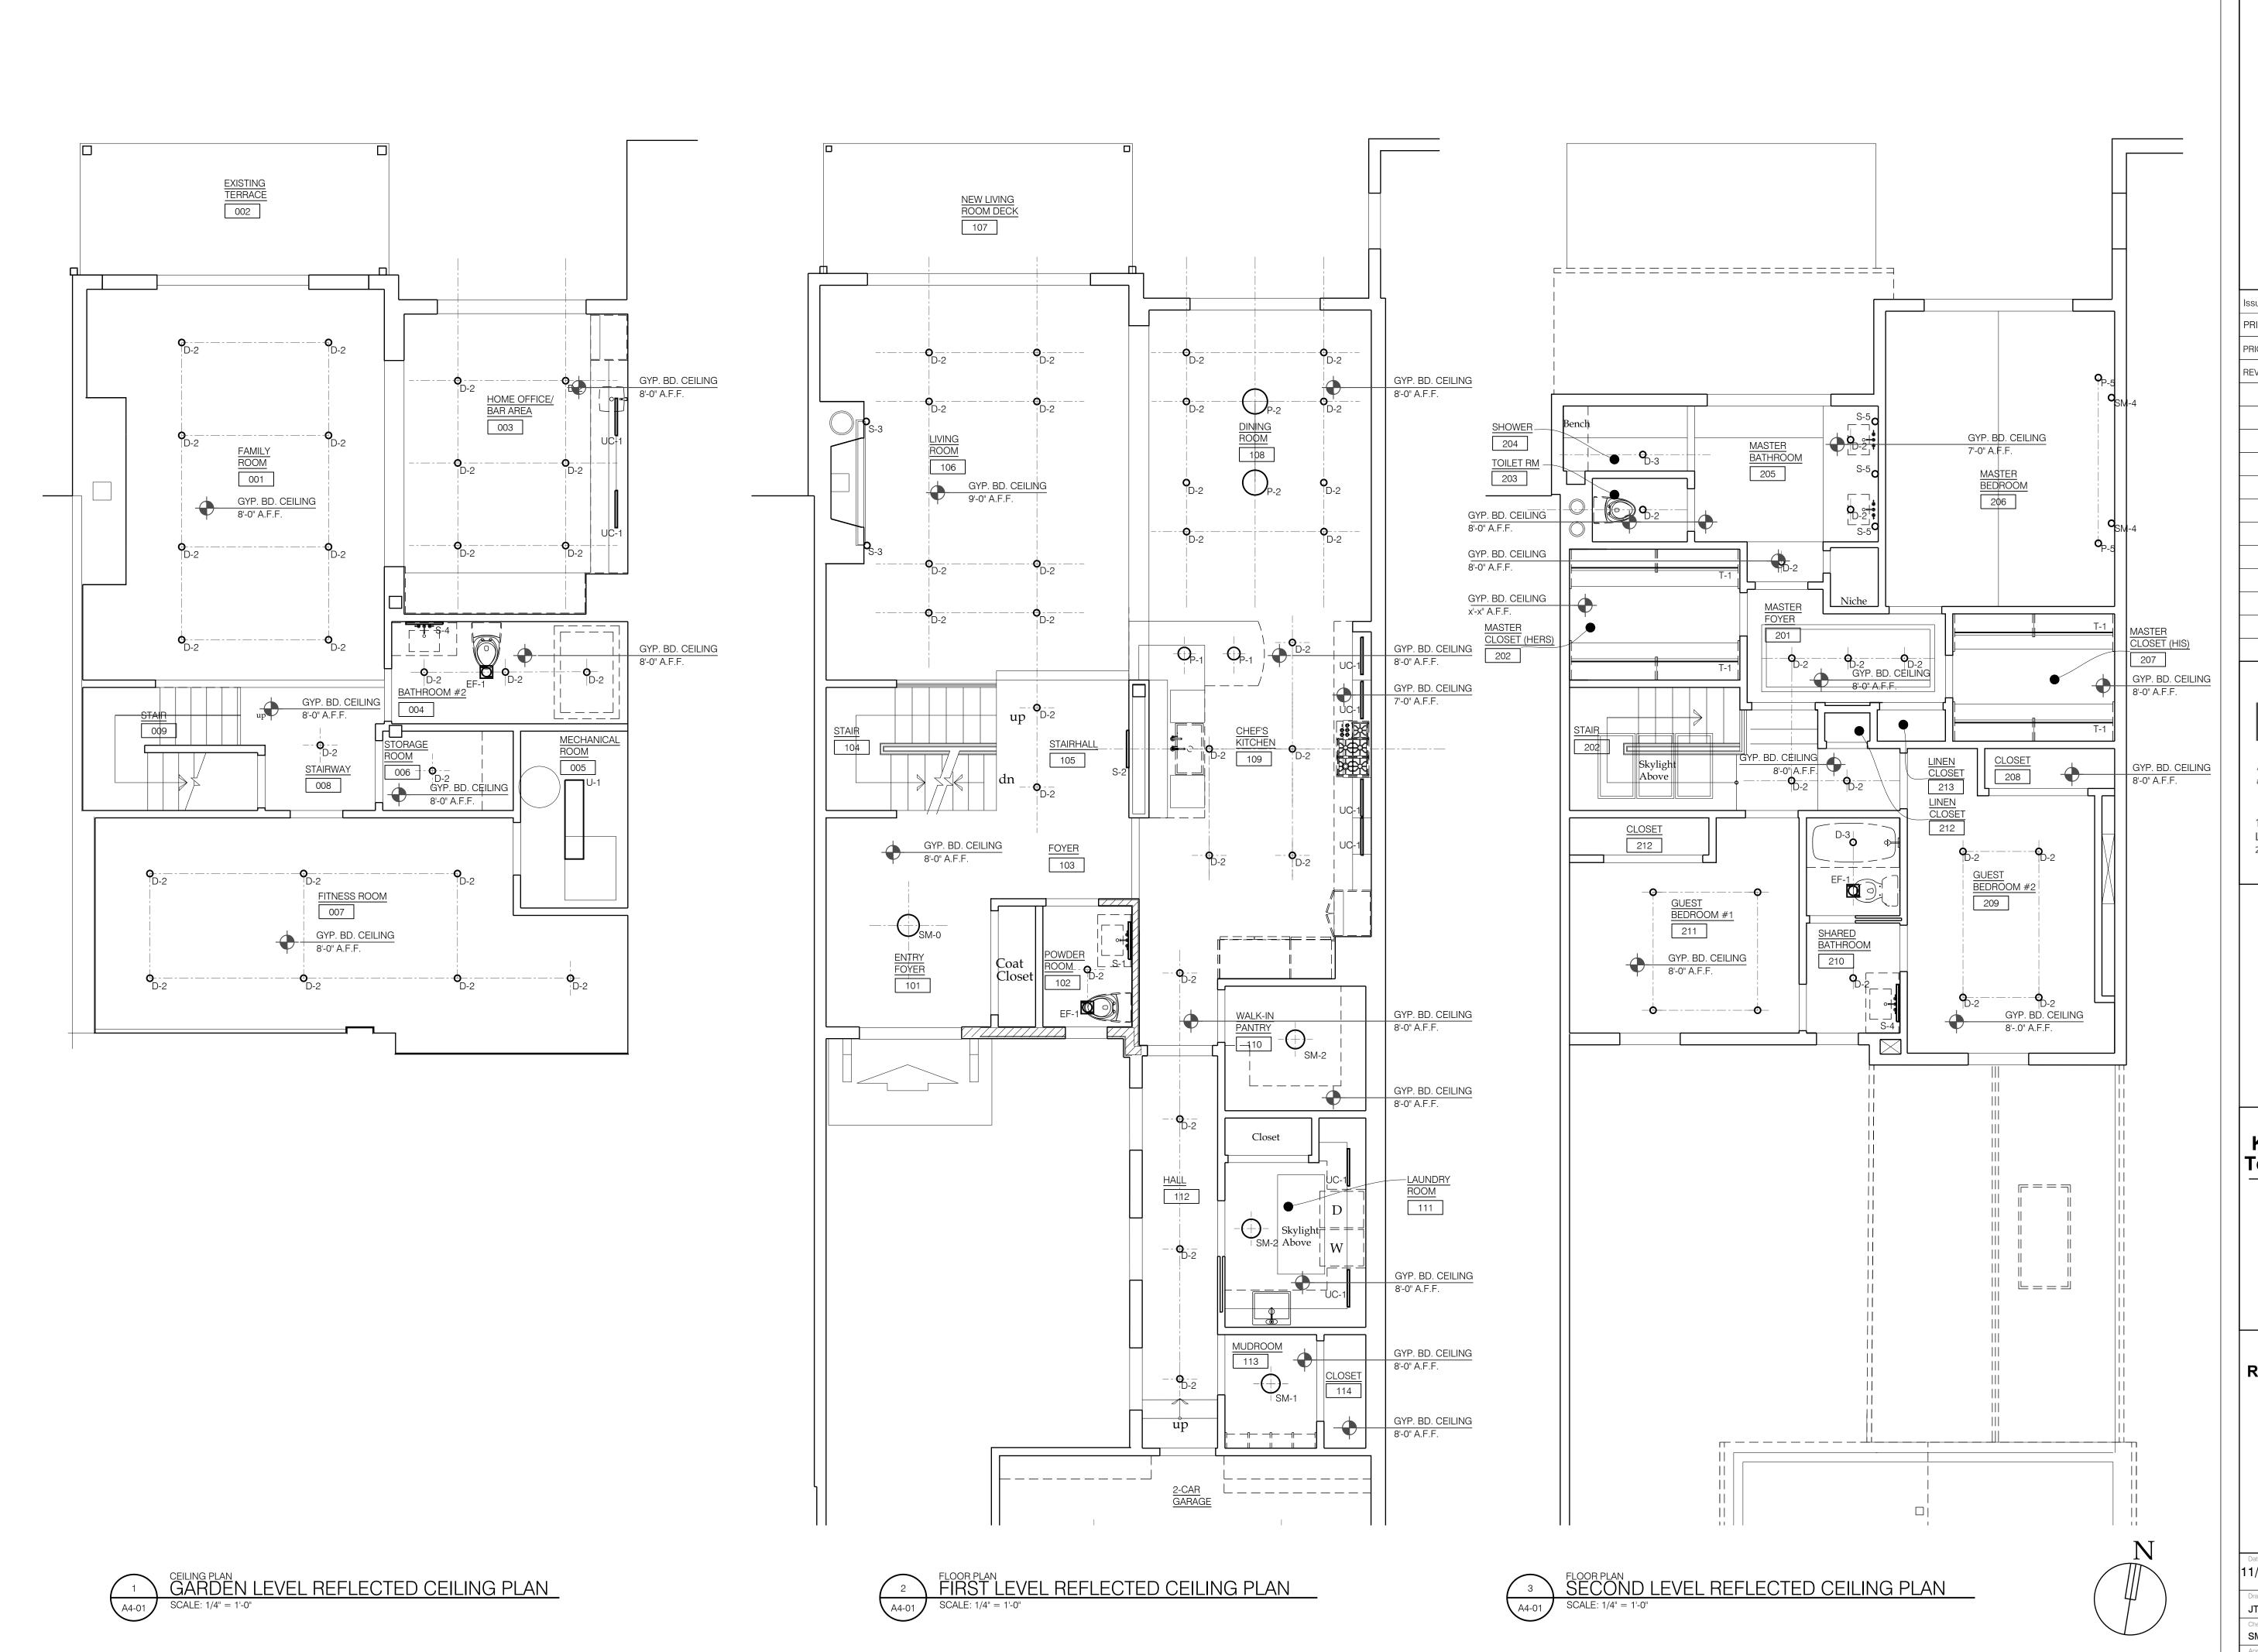
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STAIR SECTIONS, PLANS

Date	Project Number
11/29/2023	23-054
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Drawn by	Drawing Number
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Issue:	Date:	Ву:
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REFLECTED CEILING PLAN

11/29/2023 23-054

Drawn by

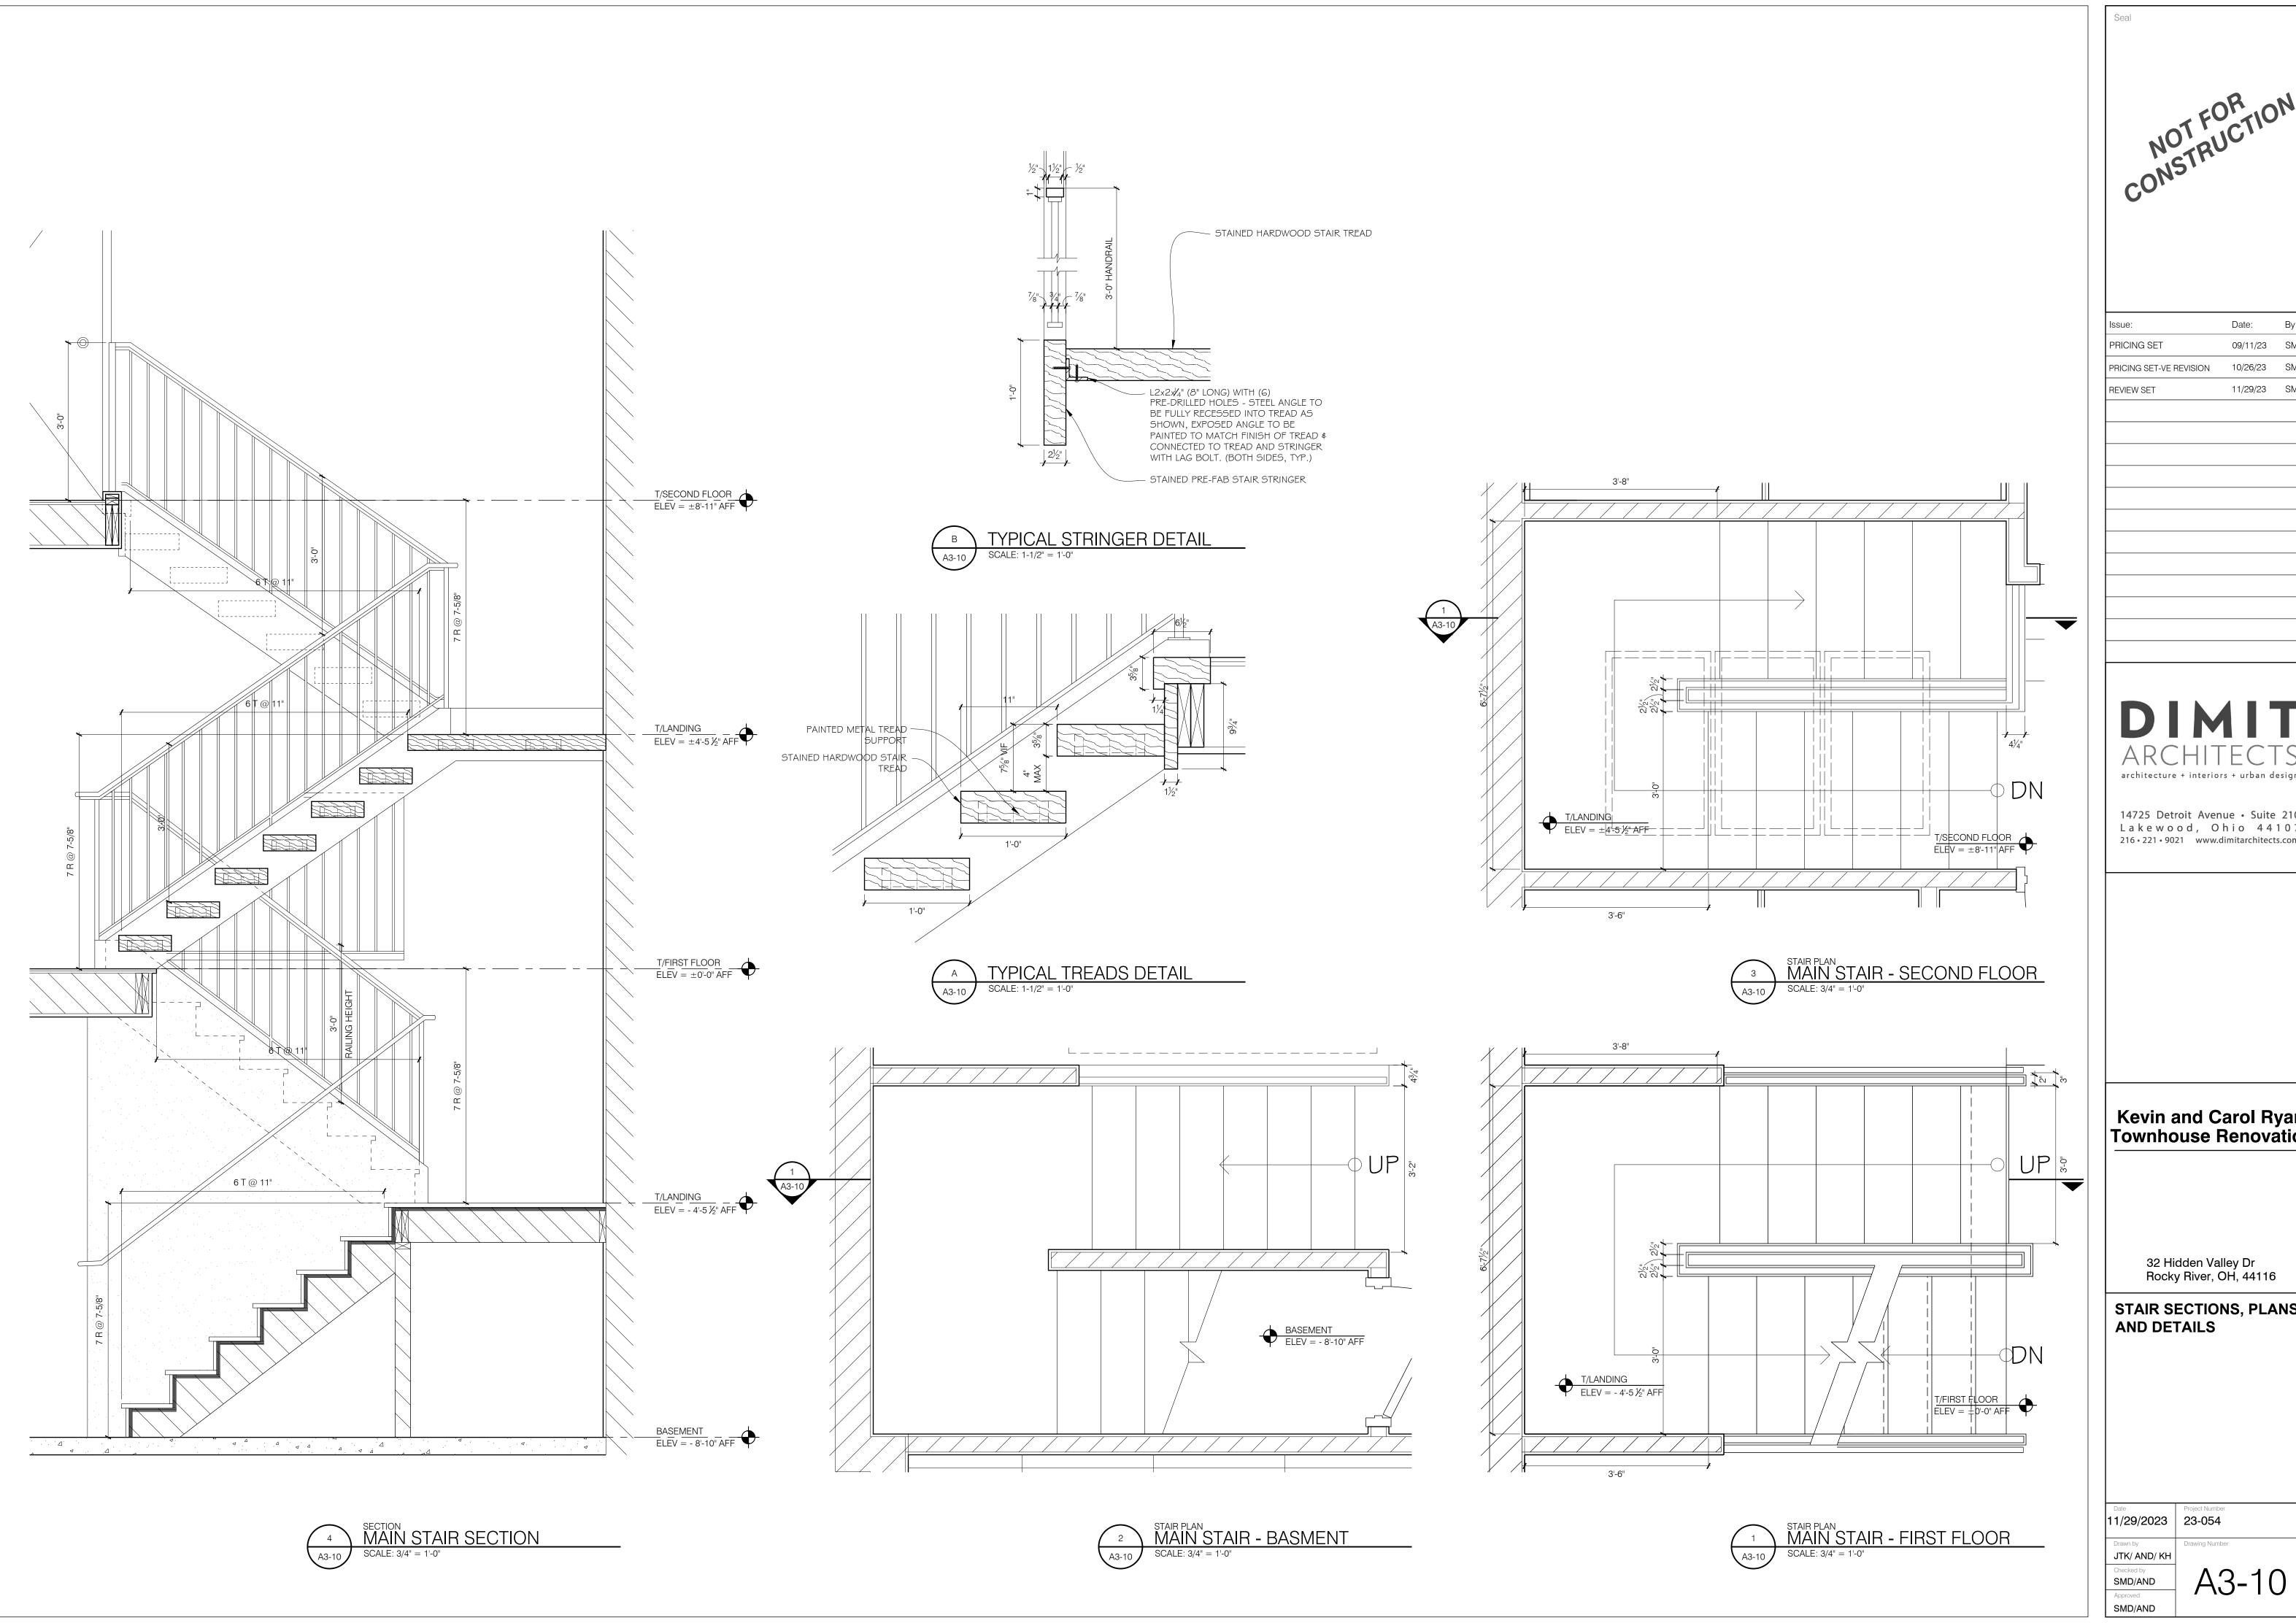JTK/ AND/ KH

Checked by

SMD/AND

Approved

Toject Number

23-054

Drawing Number

A4-01

SMD/AND

LIGHTI	NG FIX	TURE SCH	HEDULE					
SYMBOL	ТҮРЕ	LAMPS/ WATTS	MOUNTING	MODEL	DESCRIPTION	FINISH	NOTES	VENDOR
×	CF-1	TBD	SURFACE MOUNTED	TBD	CEILING FAN	TBD	TBD	TBD
\times	CF-2	TBD	SURFACE MOUNTED	TBD	CEILING FAN	TBD	TBD	TBD
	CL-1	TBD	SURFACE-MOUNTED	TBD	TBD	TBD	TBD	TBD
0	D-1	TBD	CEILING RECESSED	TBD	RECESSED DOWNLIGHT	TBD	TBD	TBD
0	D-2	TBD	CEILING RECESSED	TBD	WET-RATED RECESSED DOWNLIGHT	TBD	TBD	TBD
•	D-3	TBD	CEILING RECESSED	TBD	RECESSED DOWNLIGHT	TBD	TBD	TBD
0	D-4	TBD	CEILING RECESSED	TBD	RECESSED DOWNLIGHT	TBD	TBD	TBD
•	D-5	TBD	CEILING RECESSED	TBD	RECESSED DIRECTIONAL	TBD	TBD	TBD
0	ES-1	TBD	SURFACE-MOUNTED	TBD	TBD	TBD	TBD	TBD
Ø	EF-1	TBD	EXHAUST FAN	TBD	EXHAUST FAN	TBD	TBD	TBD
	P-1	TBD	PENDANT	TBD	DECORATIVE PENDANT FIXTURE-	TBD	TBD	TBD
0	P-2	TBD	PENDANT	TBD	DECORATIVE PENDANT FIXTURE-KITCHEN	TBD	TBD	TBD
	P-3	TBD	PENDANT	TBD	DECORATIVE PENDANT FIXTURE-STAIR	TBD	TBD	TBD
0	P-4	TBD	PENDANT	TBD	DECORATIVE PENDANT FIXTURE-POWDER ROOM	TBD	TBD	TBD
0	P-5	TBD	PENDANT	TBD	DECORATIVE PENDANT FIXTURE-MASTER BEDROOM	TBD	TBD	TBD
	SM-1	TBD	SURFACE-MOUNTED	TBD	TBD	TBD	TBD	TBD
_	SM-2	TBD	SURFACE-MOUNTED	TBD	TBD	TBD	TBD	TBD
0	SM-3	TBD	SURFACE-MOUNTED	TBD	TBD	TBD	TBD	TBD
0	SM-4	TBD	SURFACE-MOUNTED	TBD	READING LIGHT-MASTER BEDROOM	TBD	TBD	TBD
-	ST-1	TBD	SURFACE-MOUNTED	TBD	WALL-MOUNTED STEP LIGHT	TBD	TBD	TBD
	U-1	TBD	SURFACE-MOUNTED	TBD	UTILITY LIGHT	TBD	TBD	TBD
_	UC-1	TBD	SURFACE-MOUNTED	TBD	UNDER CABINET LIGHT	TBD	TBD	TBD
	T-1	TBD	SURFACE-MOUNTED	TBD	TBD	TBD	TBD	TBD

Issue:	Date:	Ву:
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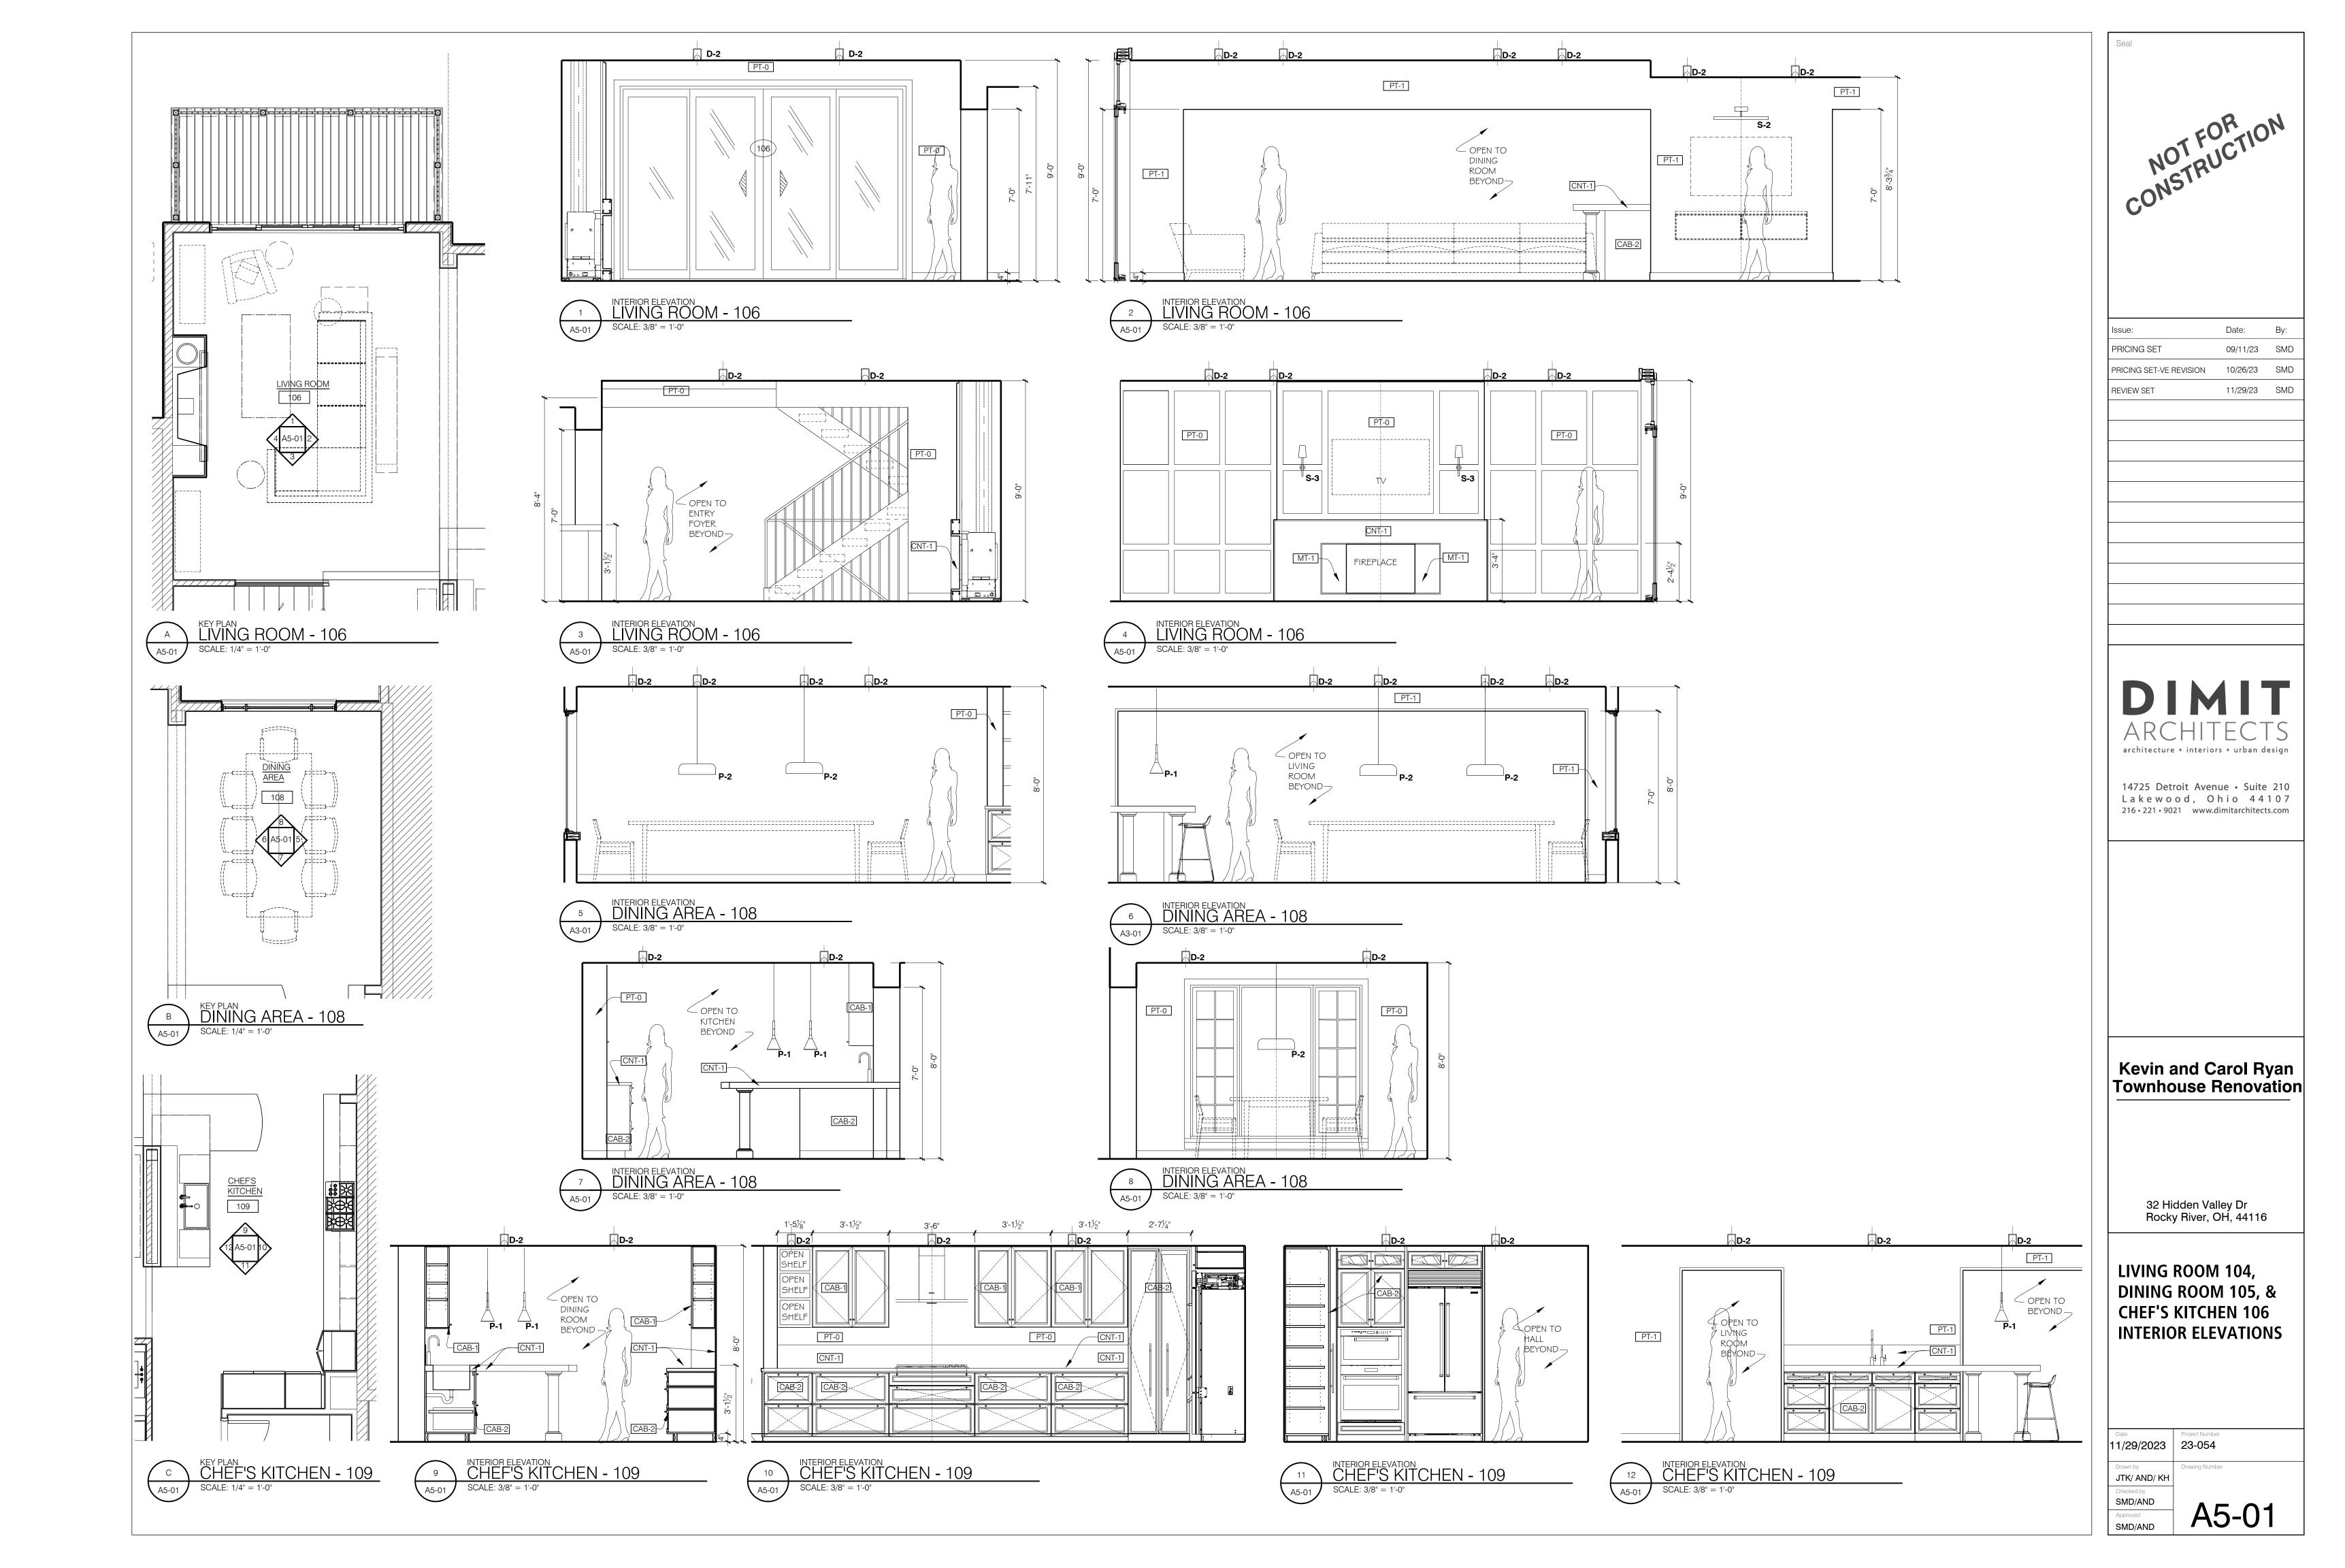
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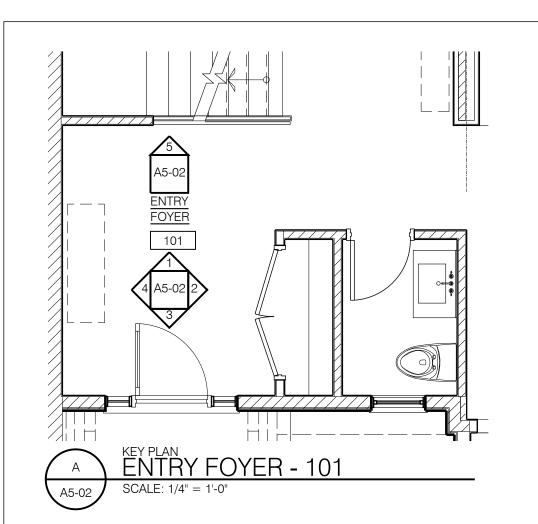
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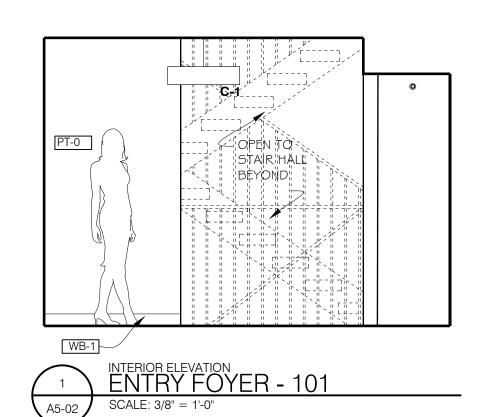
LIGHTING SCHEDULE


Date 11/29/2023	Project Number 23-054
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SMD/AND











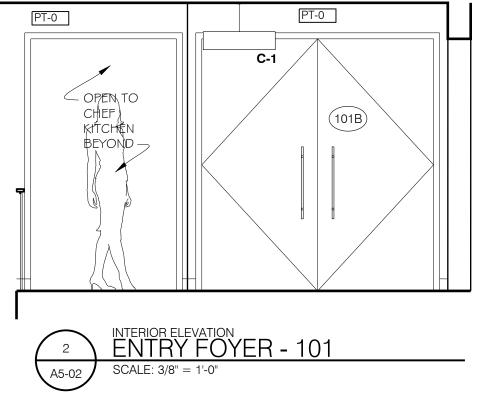

D-2

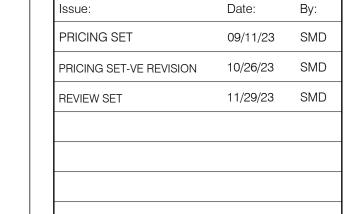


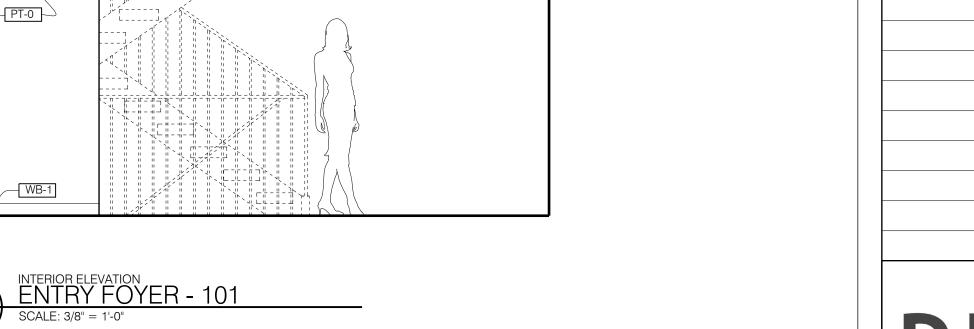




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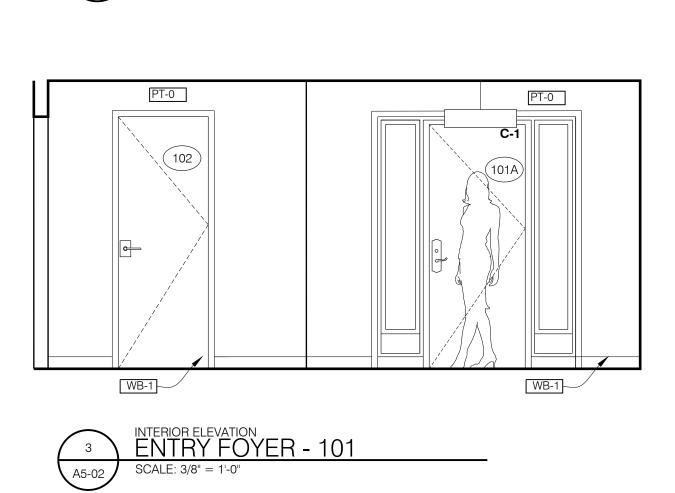


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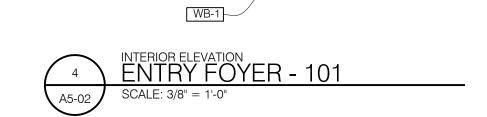
ENTRY FOYER 101, & POWDER ROOM 102 INTERIOR ELEVATIONS

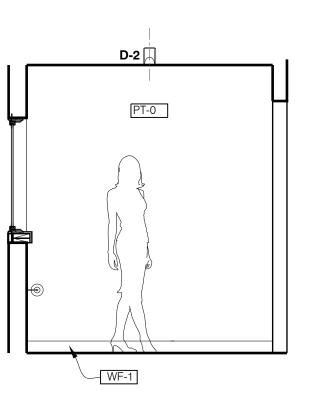1/29/2023	Project Number 23-054
Drawn by JTK/ AND/ KH	Drawing Number
Checked by SMD/AND	A5-02
Approved	

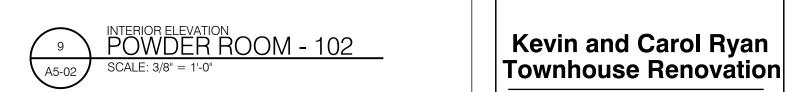
SMD/AND




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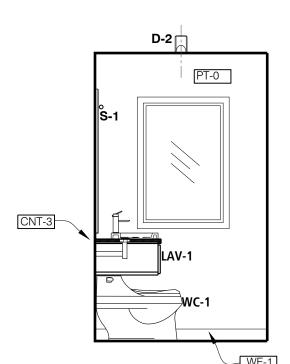
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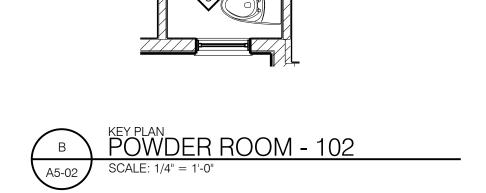






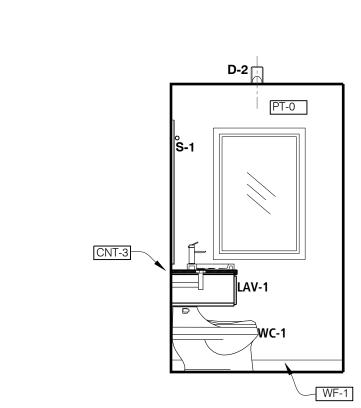




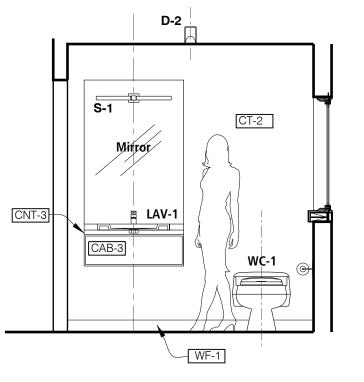


INTERIOR ELEVATION POWDER ROOM - 102


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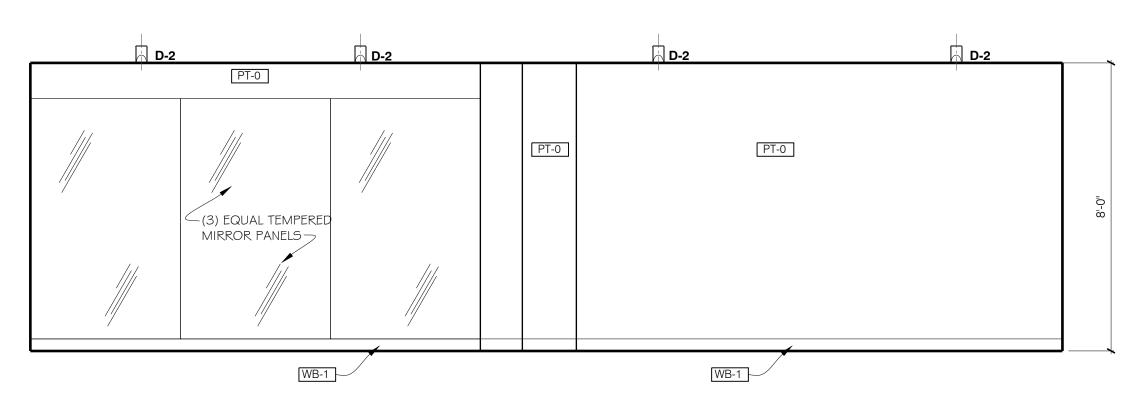


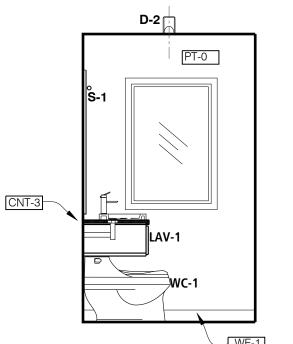




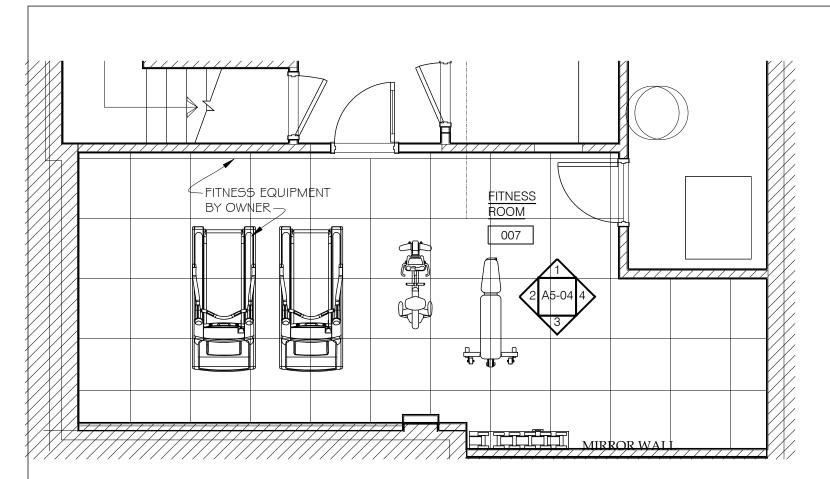




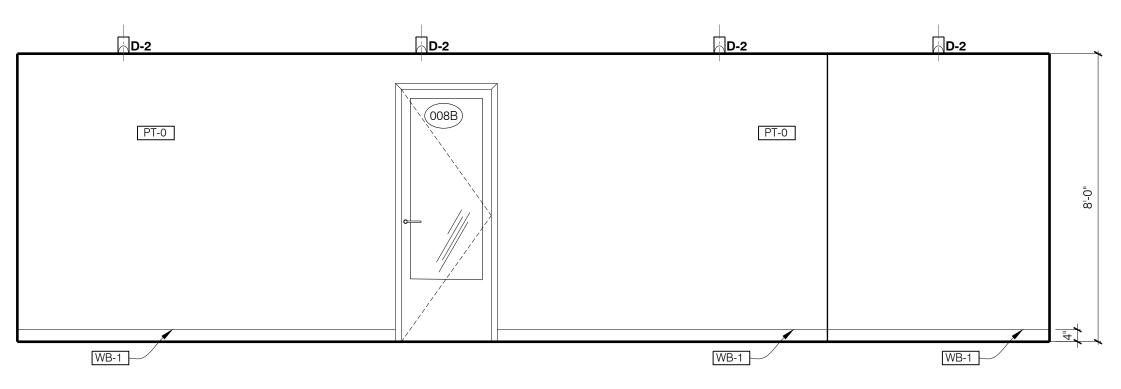

FITNESS ROOM - 007 FITNESS ROOM - 007 SCALE: 3/8" = 1'-0"

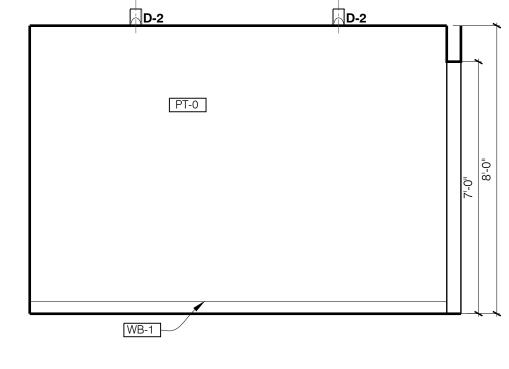


2 INTERIOR ELEVATION FITNESS ROOM - 007
SCALE: 3/8" = 1'-0"

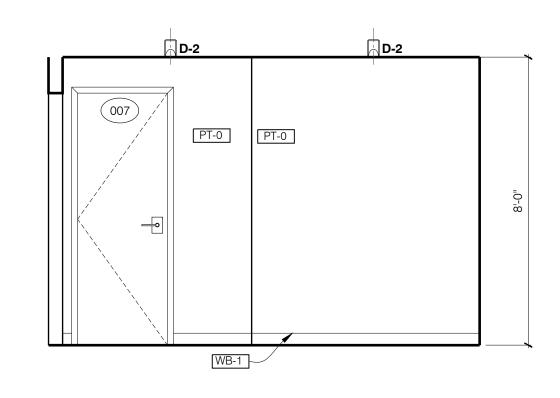


INTERIOR ELEVATION FITNESS ROOM - 007


SCALE: 3/8" = 1'-0"

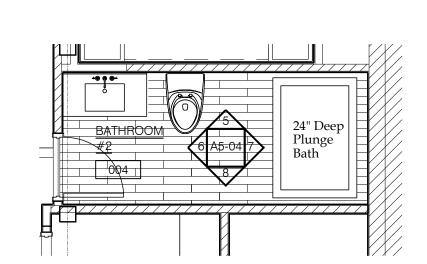

B BATHROOM #2 - 004
SCALE: 1/4" = 1'-0"

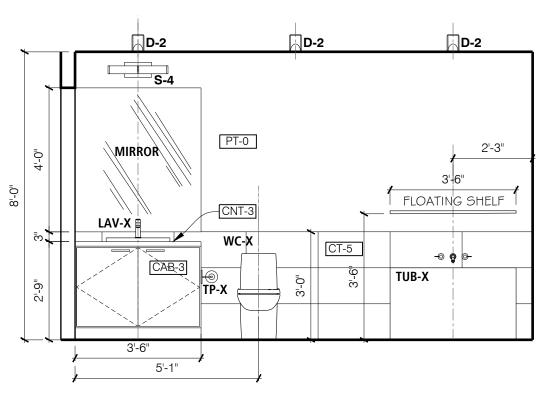




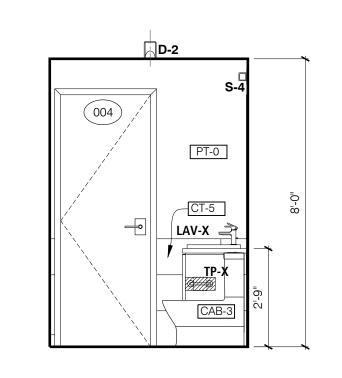


6 BATHROOM #2 - 004

SCALE: 3/8" = 1'-0"

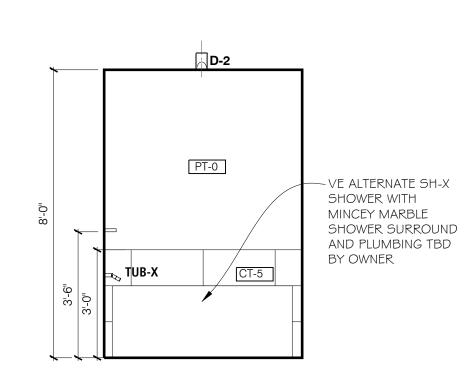

7	INTERIOR ELEVATION BATHROOM #2 - 004
A5-04	SCALE: 3/8" = 1'-0"

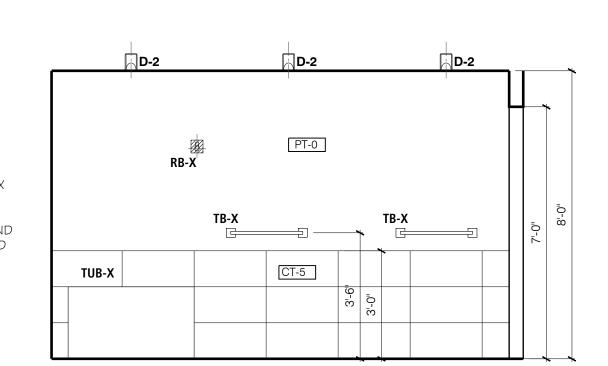

8 BATHROOM #2 - 004 SCALE: 3/8" = 1'-0"

CONSTRUCTION

Issue:	Date:	Ву:
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PRICING SET-VE REVISION	10/26/23	SMD
REVIEW SET	11/29/23	SMD

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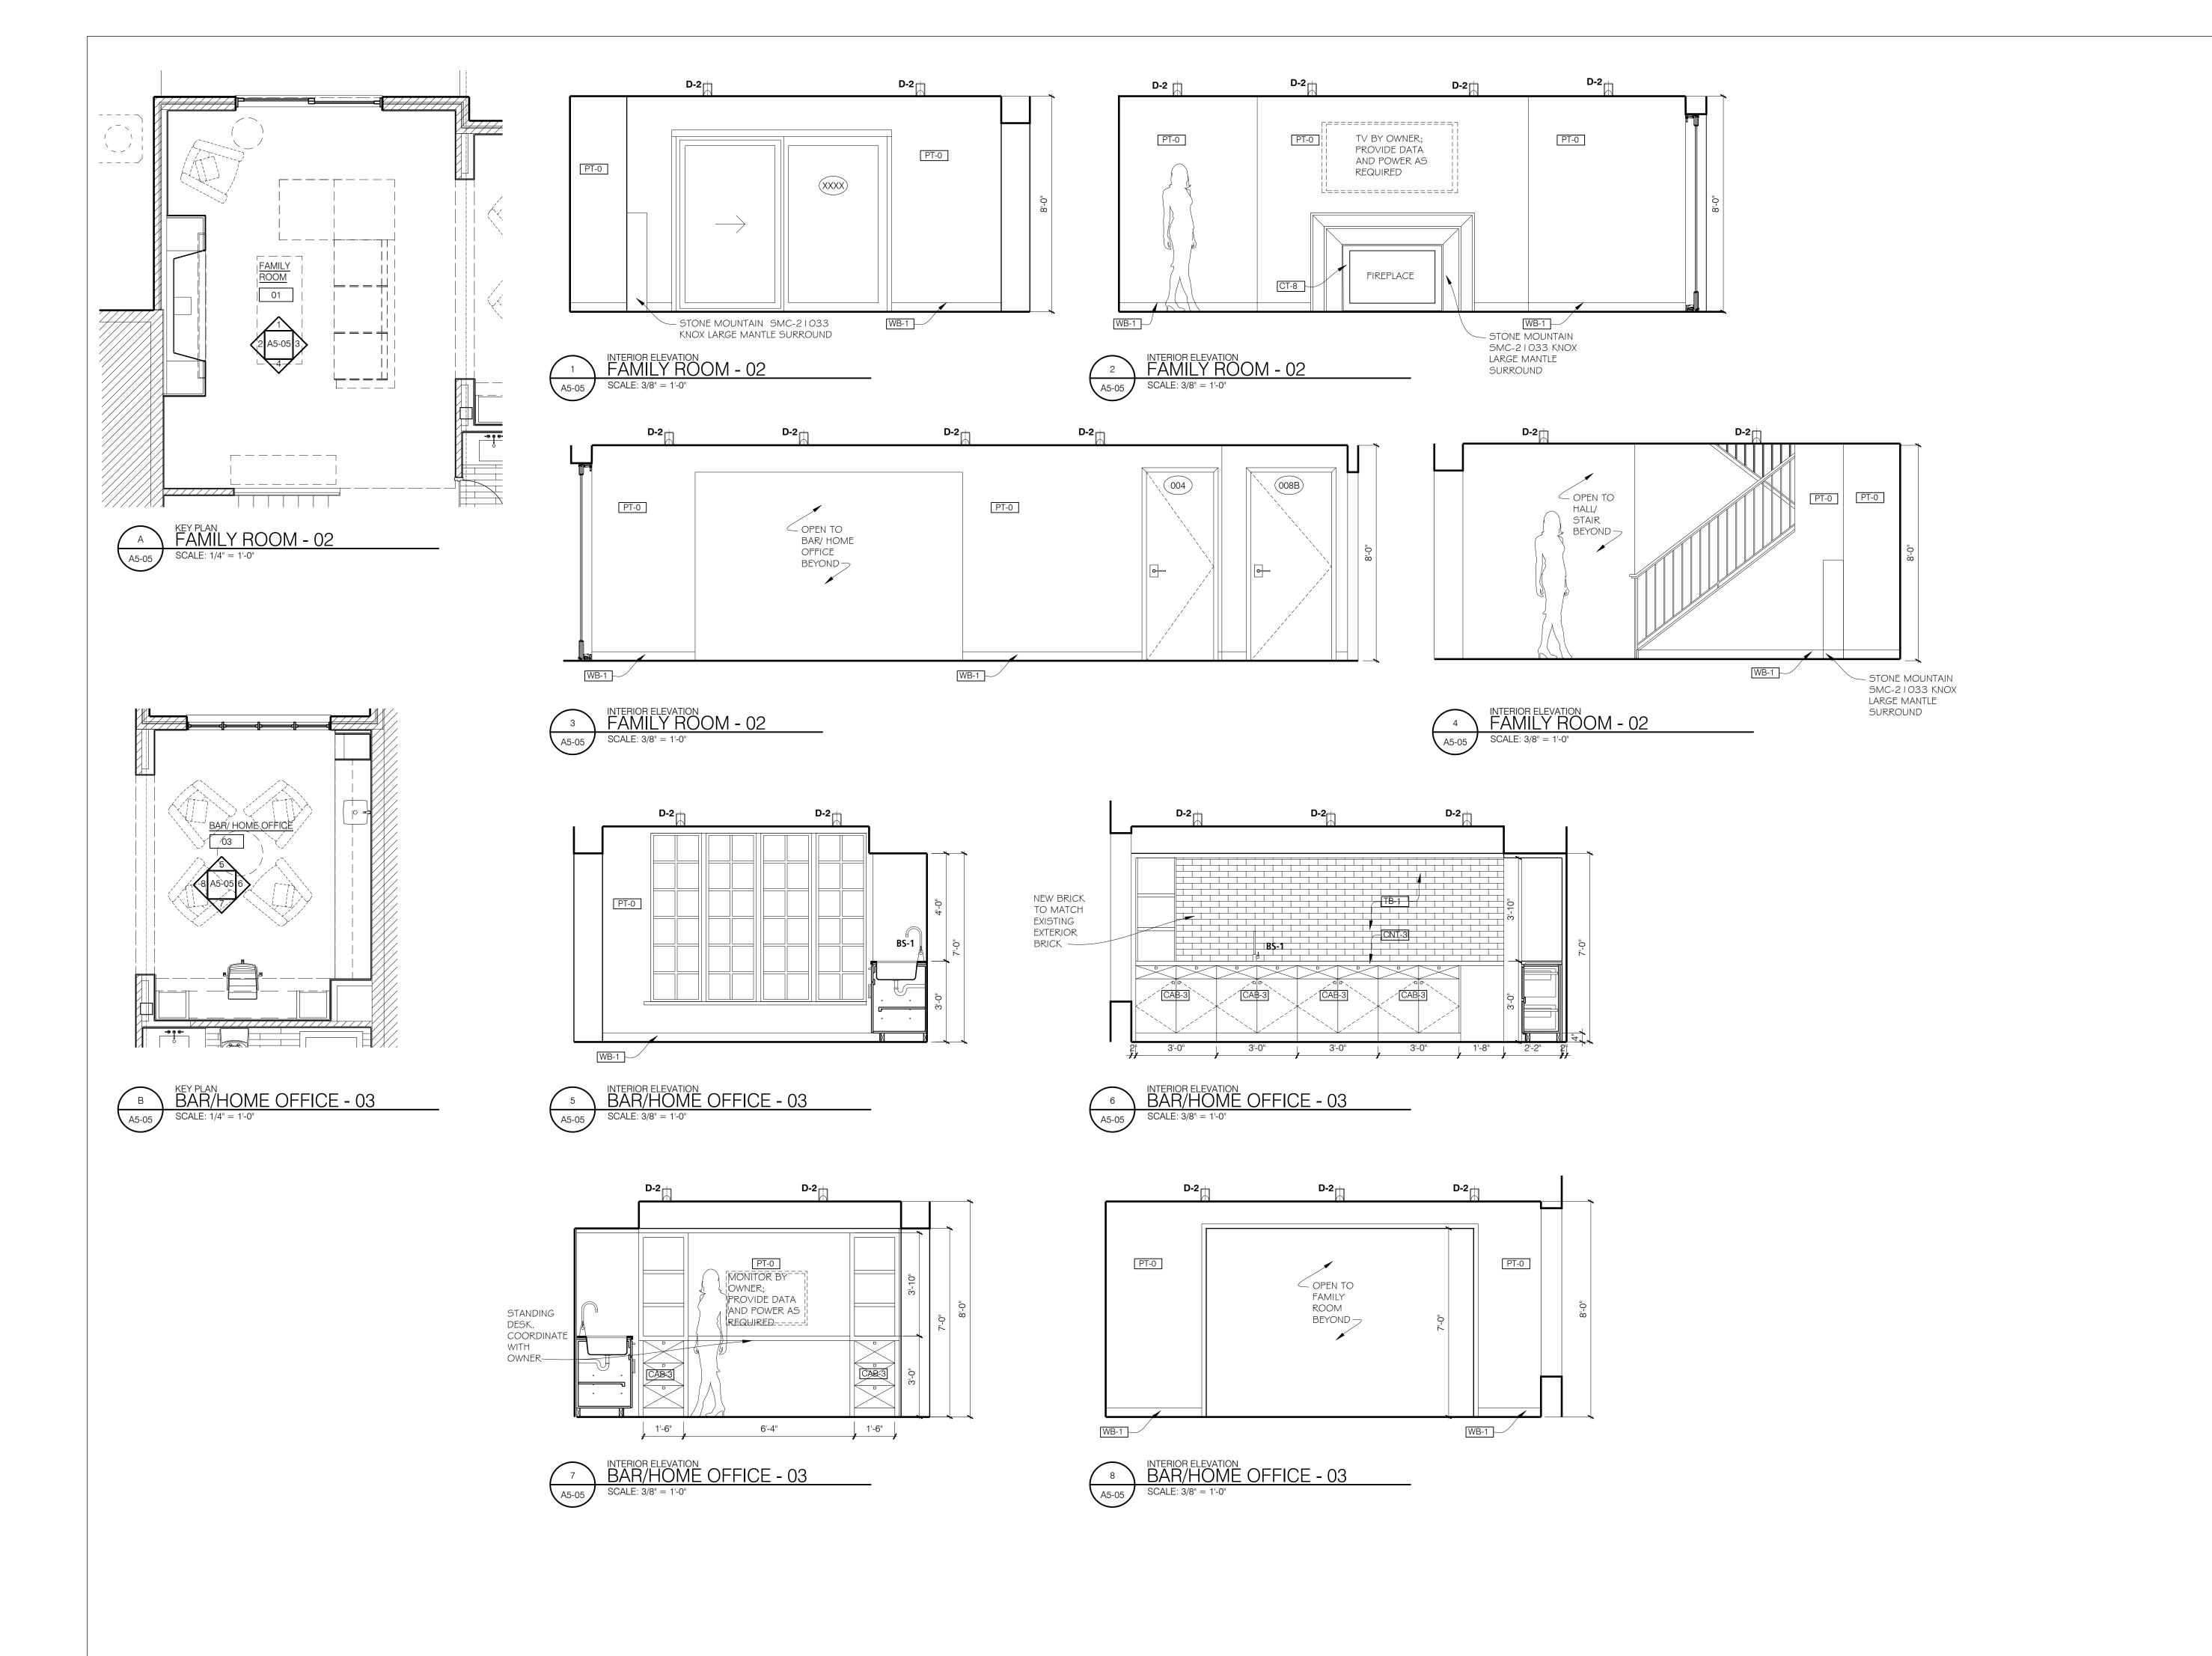
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FITNESS ROOM 00, STAIRWAY 01, & BATHROOM #2 04 INTERIOR ELEVATIONS

Date 11/29/2023	Project Number 23-054
JTK/ AND/ KH	Drawing Number
Checked by SMD/AND	A C O 4
Approved SMD/AND	A5-04



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	Issue:	Date:	By:
	PRICING SET	09/11/23	SMD
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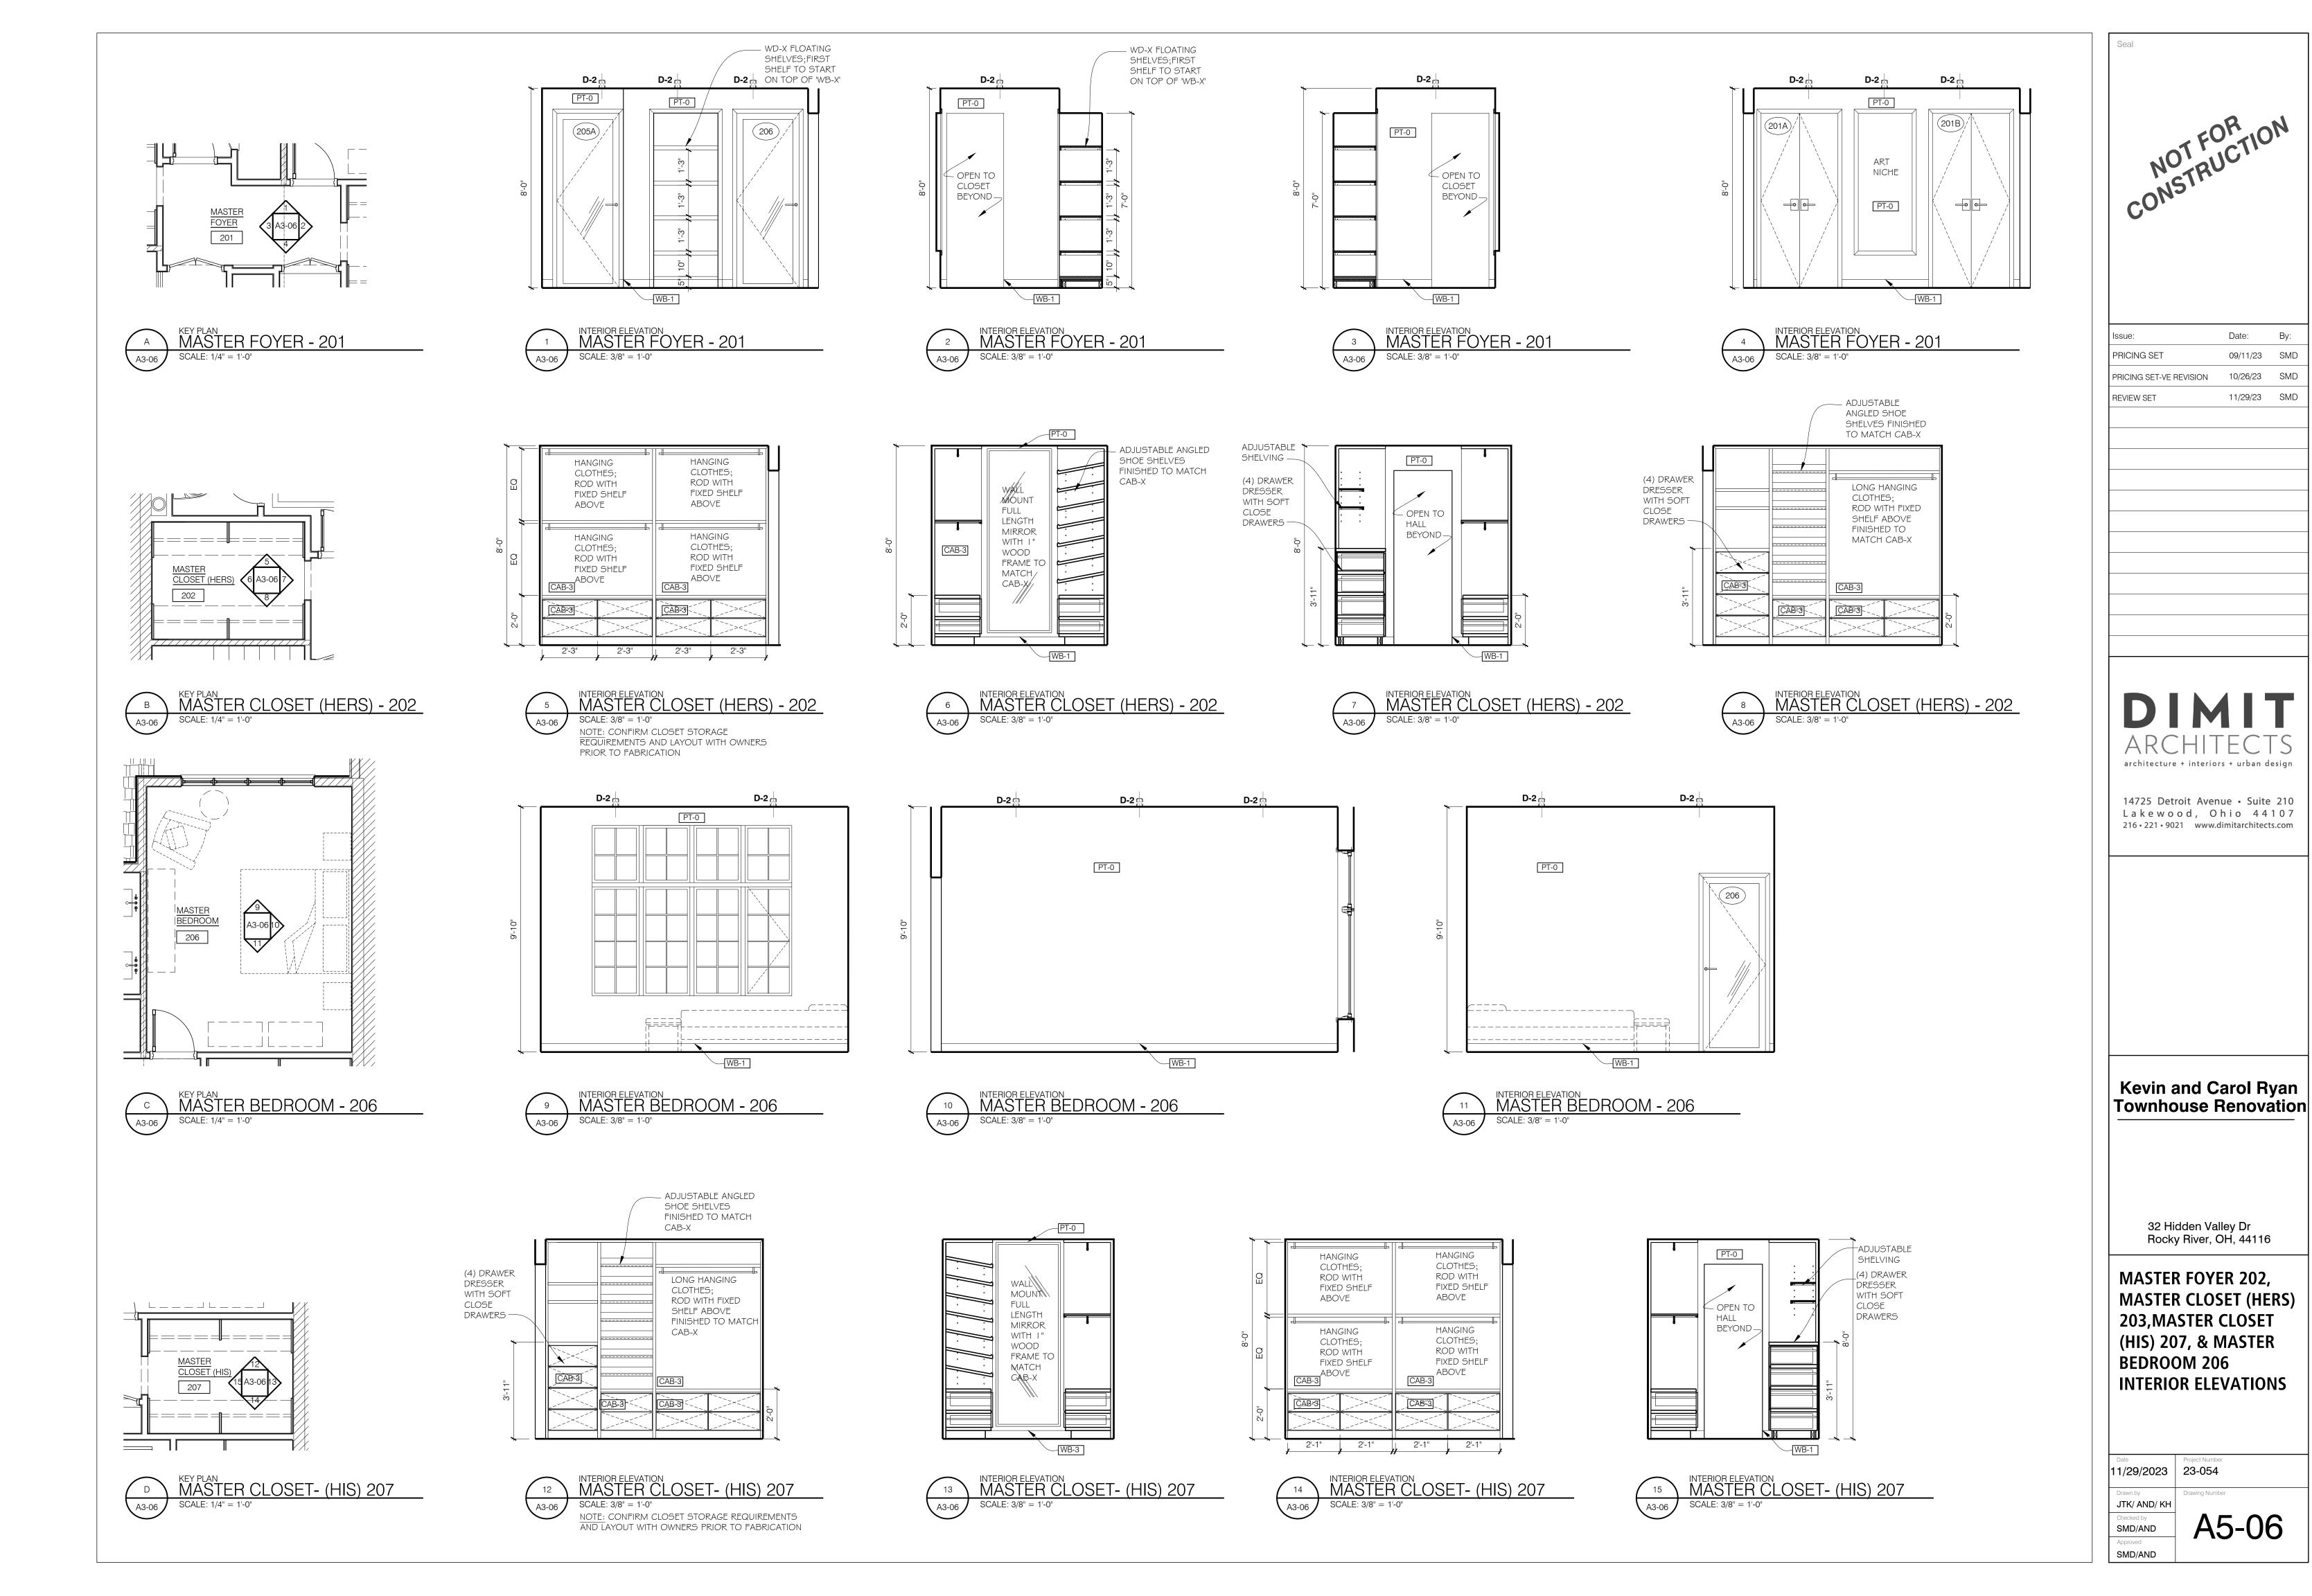
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FAMILY ROOM 02 & BAR/HOME OFFICE 03 INTERIOR ELEVATIONS

11/29/2023	Project Number 23-054
Drawn by	Drawing Number
JTK/ AND/ KH	
Checked by	

Checked by SMD/AND
Approved SMD/AND





Date:


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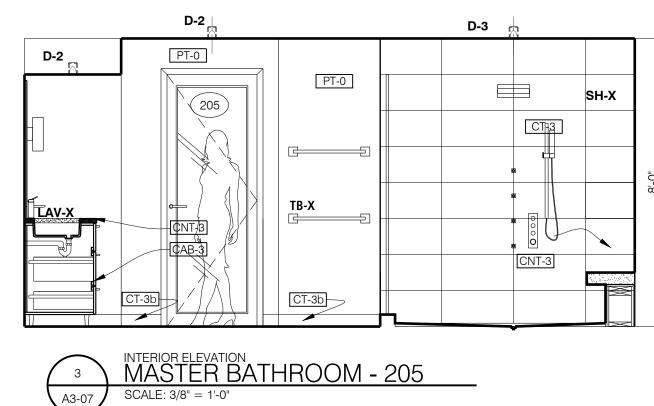
10/26/23 SMD


11/29/23 SMD



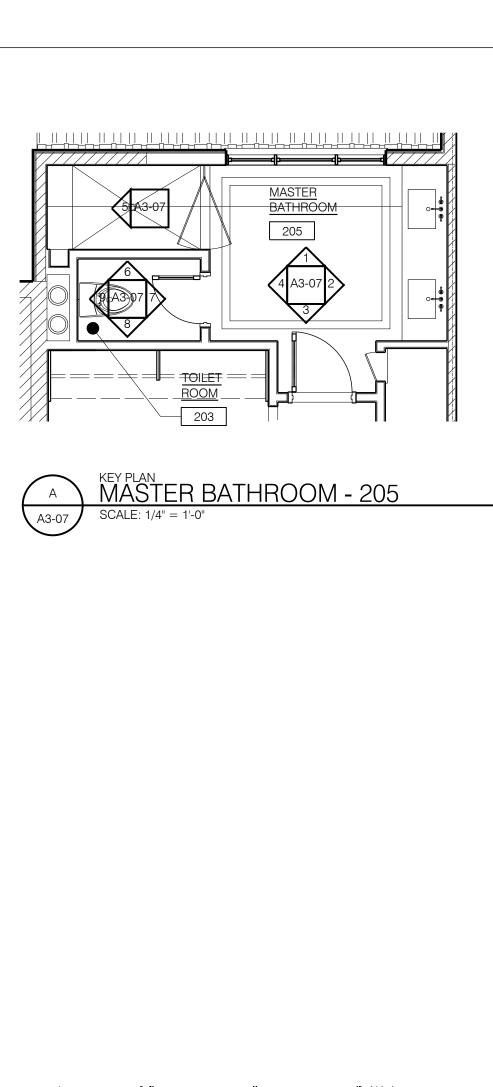


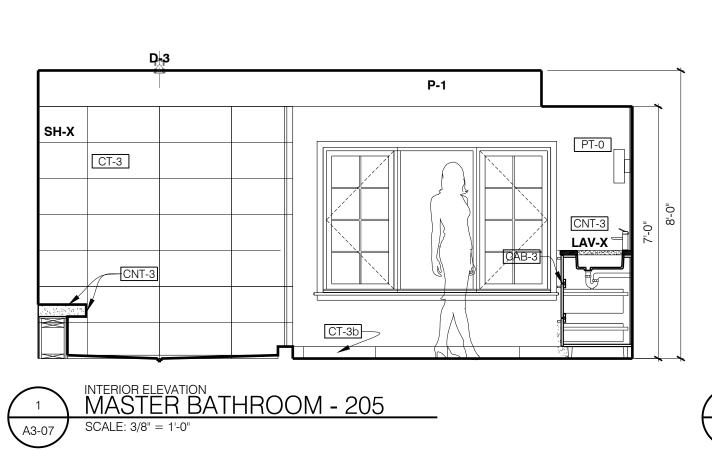

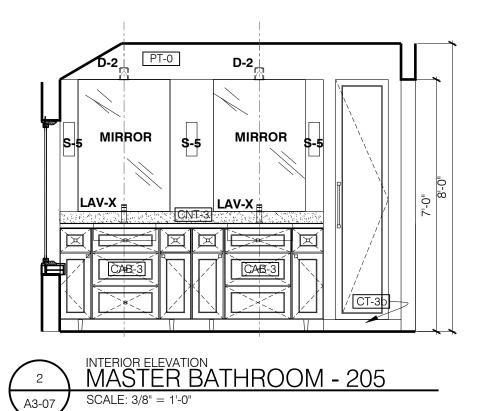


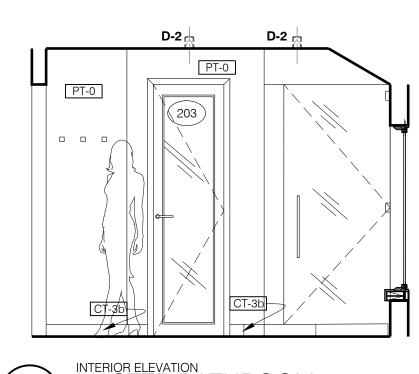





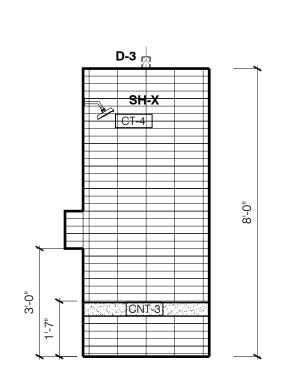




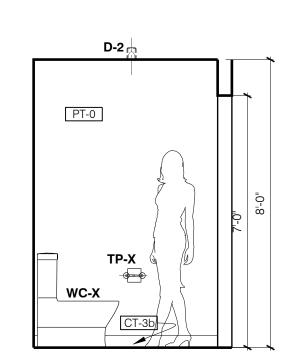

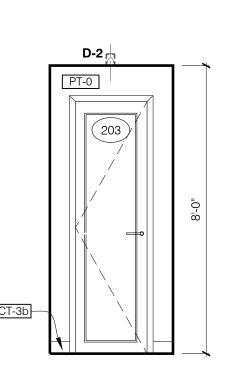

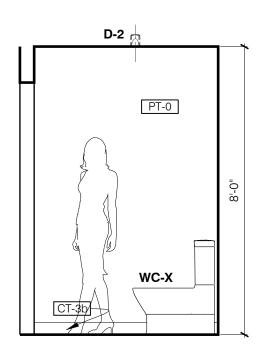




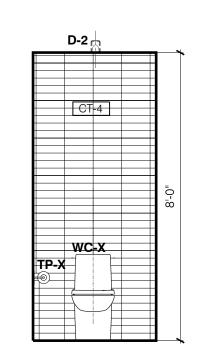


9 TOILET ROOM - 203


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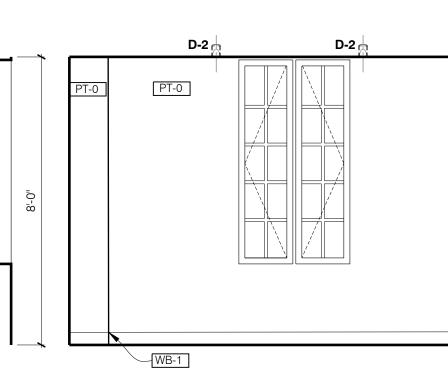
KEY PLAN GUEST BEDROOM #2 - 209 SCALE: 1/4" = 1'-0"

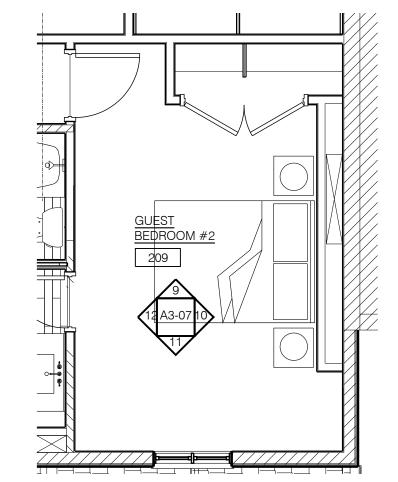


9 A3-07

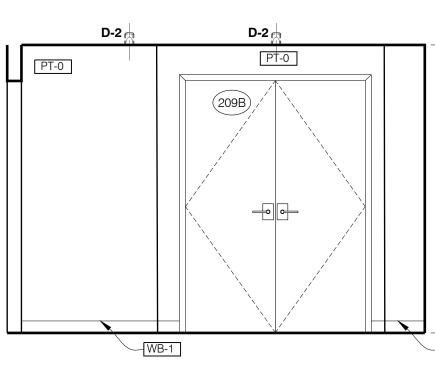


	GUEST BEDROOM #2 - 209	10	\ GUEST BEDROOM #2 - 20
)7 <i>J</i>	SCALE: 3/8" = 1'-0"	A3-07	SCALE: 3/8" = 1'-0"

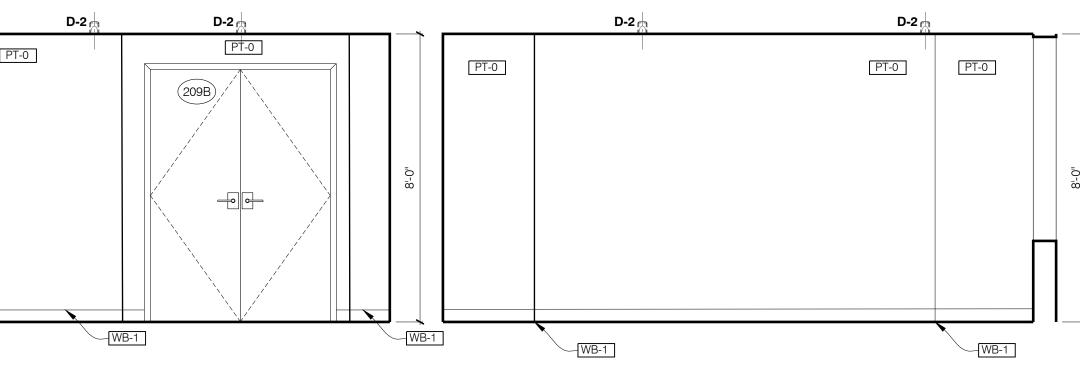

11	INTERIOR ELEVATION GUEST BEDROOM #2 - 209
A3-07	SCALE: 3/8" = 1'-0"

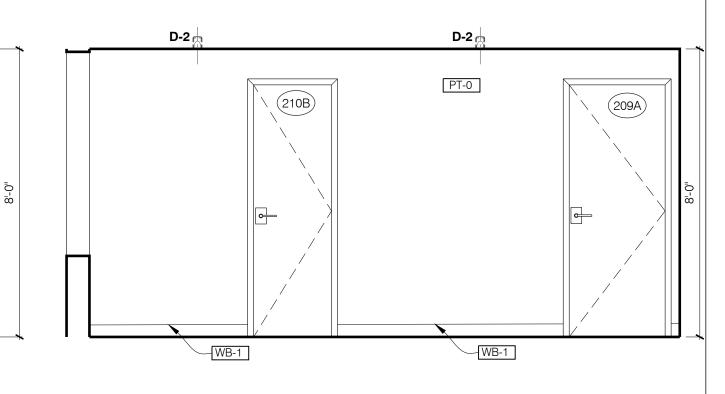




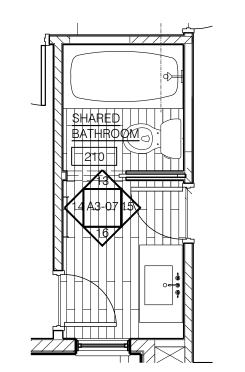


C SHARED BATHROOM - 210

SCALE: 1/4" = 1'-0"

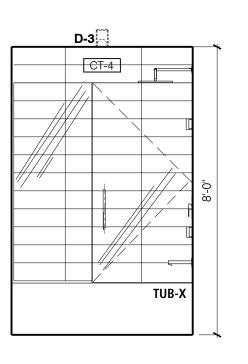


INTERIOR ELEVATION
SHARED BATHROOM - 210


SCALE: 3/8" = 1'-0"

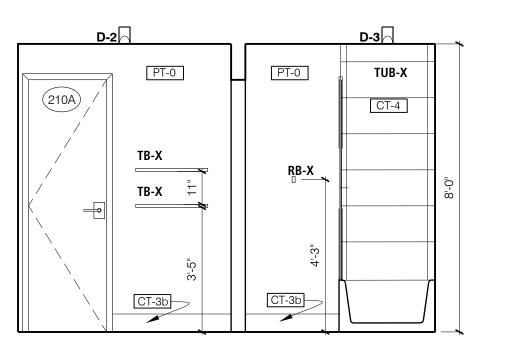

	14	INTERIOR ELEVATION SHARED BATHROOM - 210
1	A2 07	SCALE: 3/8" = 1'-0"

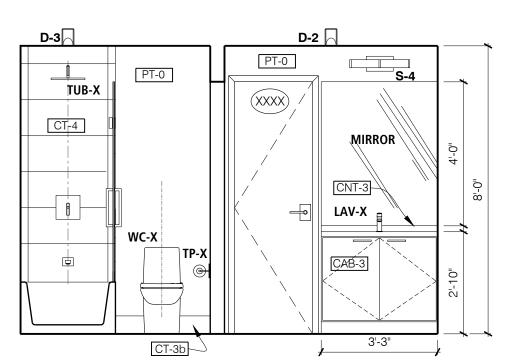

15	SHARED BATHROOM - 210	
A3-07	SCALE: 3/8" = 1'-0"	

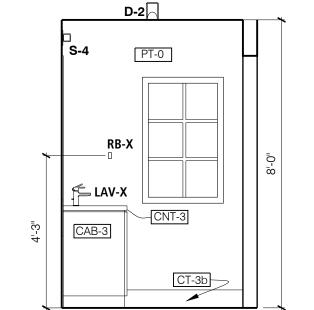

ı	16	INTERIOR ELEVATION SHARED BATHROOM - 210
	A3-07	SCALE: 3/8" = 1'-0"



Issue:	Date:	Ву:
PRICING SET	09/11/23	SMD
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MASTER BATHROOM 205, GUEST BEDROOM #2 208, & SHARED **BATHROOM 209 INTERIOR ELEVATIONS**

Drawn by JTK/ AND/ KH Checked by SMD/AND Checked by	Date 11/29/2023	Project Number 23-054
Checked by	, ,	Drawing Number
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	SMD/AND	



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CONSTRUCTION

Issue:	Date:	Ву:
PRICING SET	09/11/23	SMD
DRICING SET VE REVISION	10/26/23	SMD

PRICING SET 09/11/23 SMD
PRICING SET-VE REVISION 10/26/23 SMD

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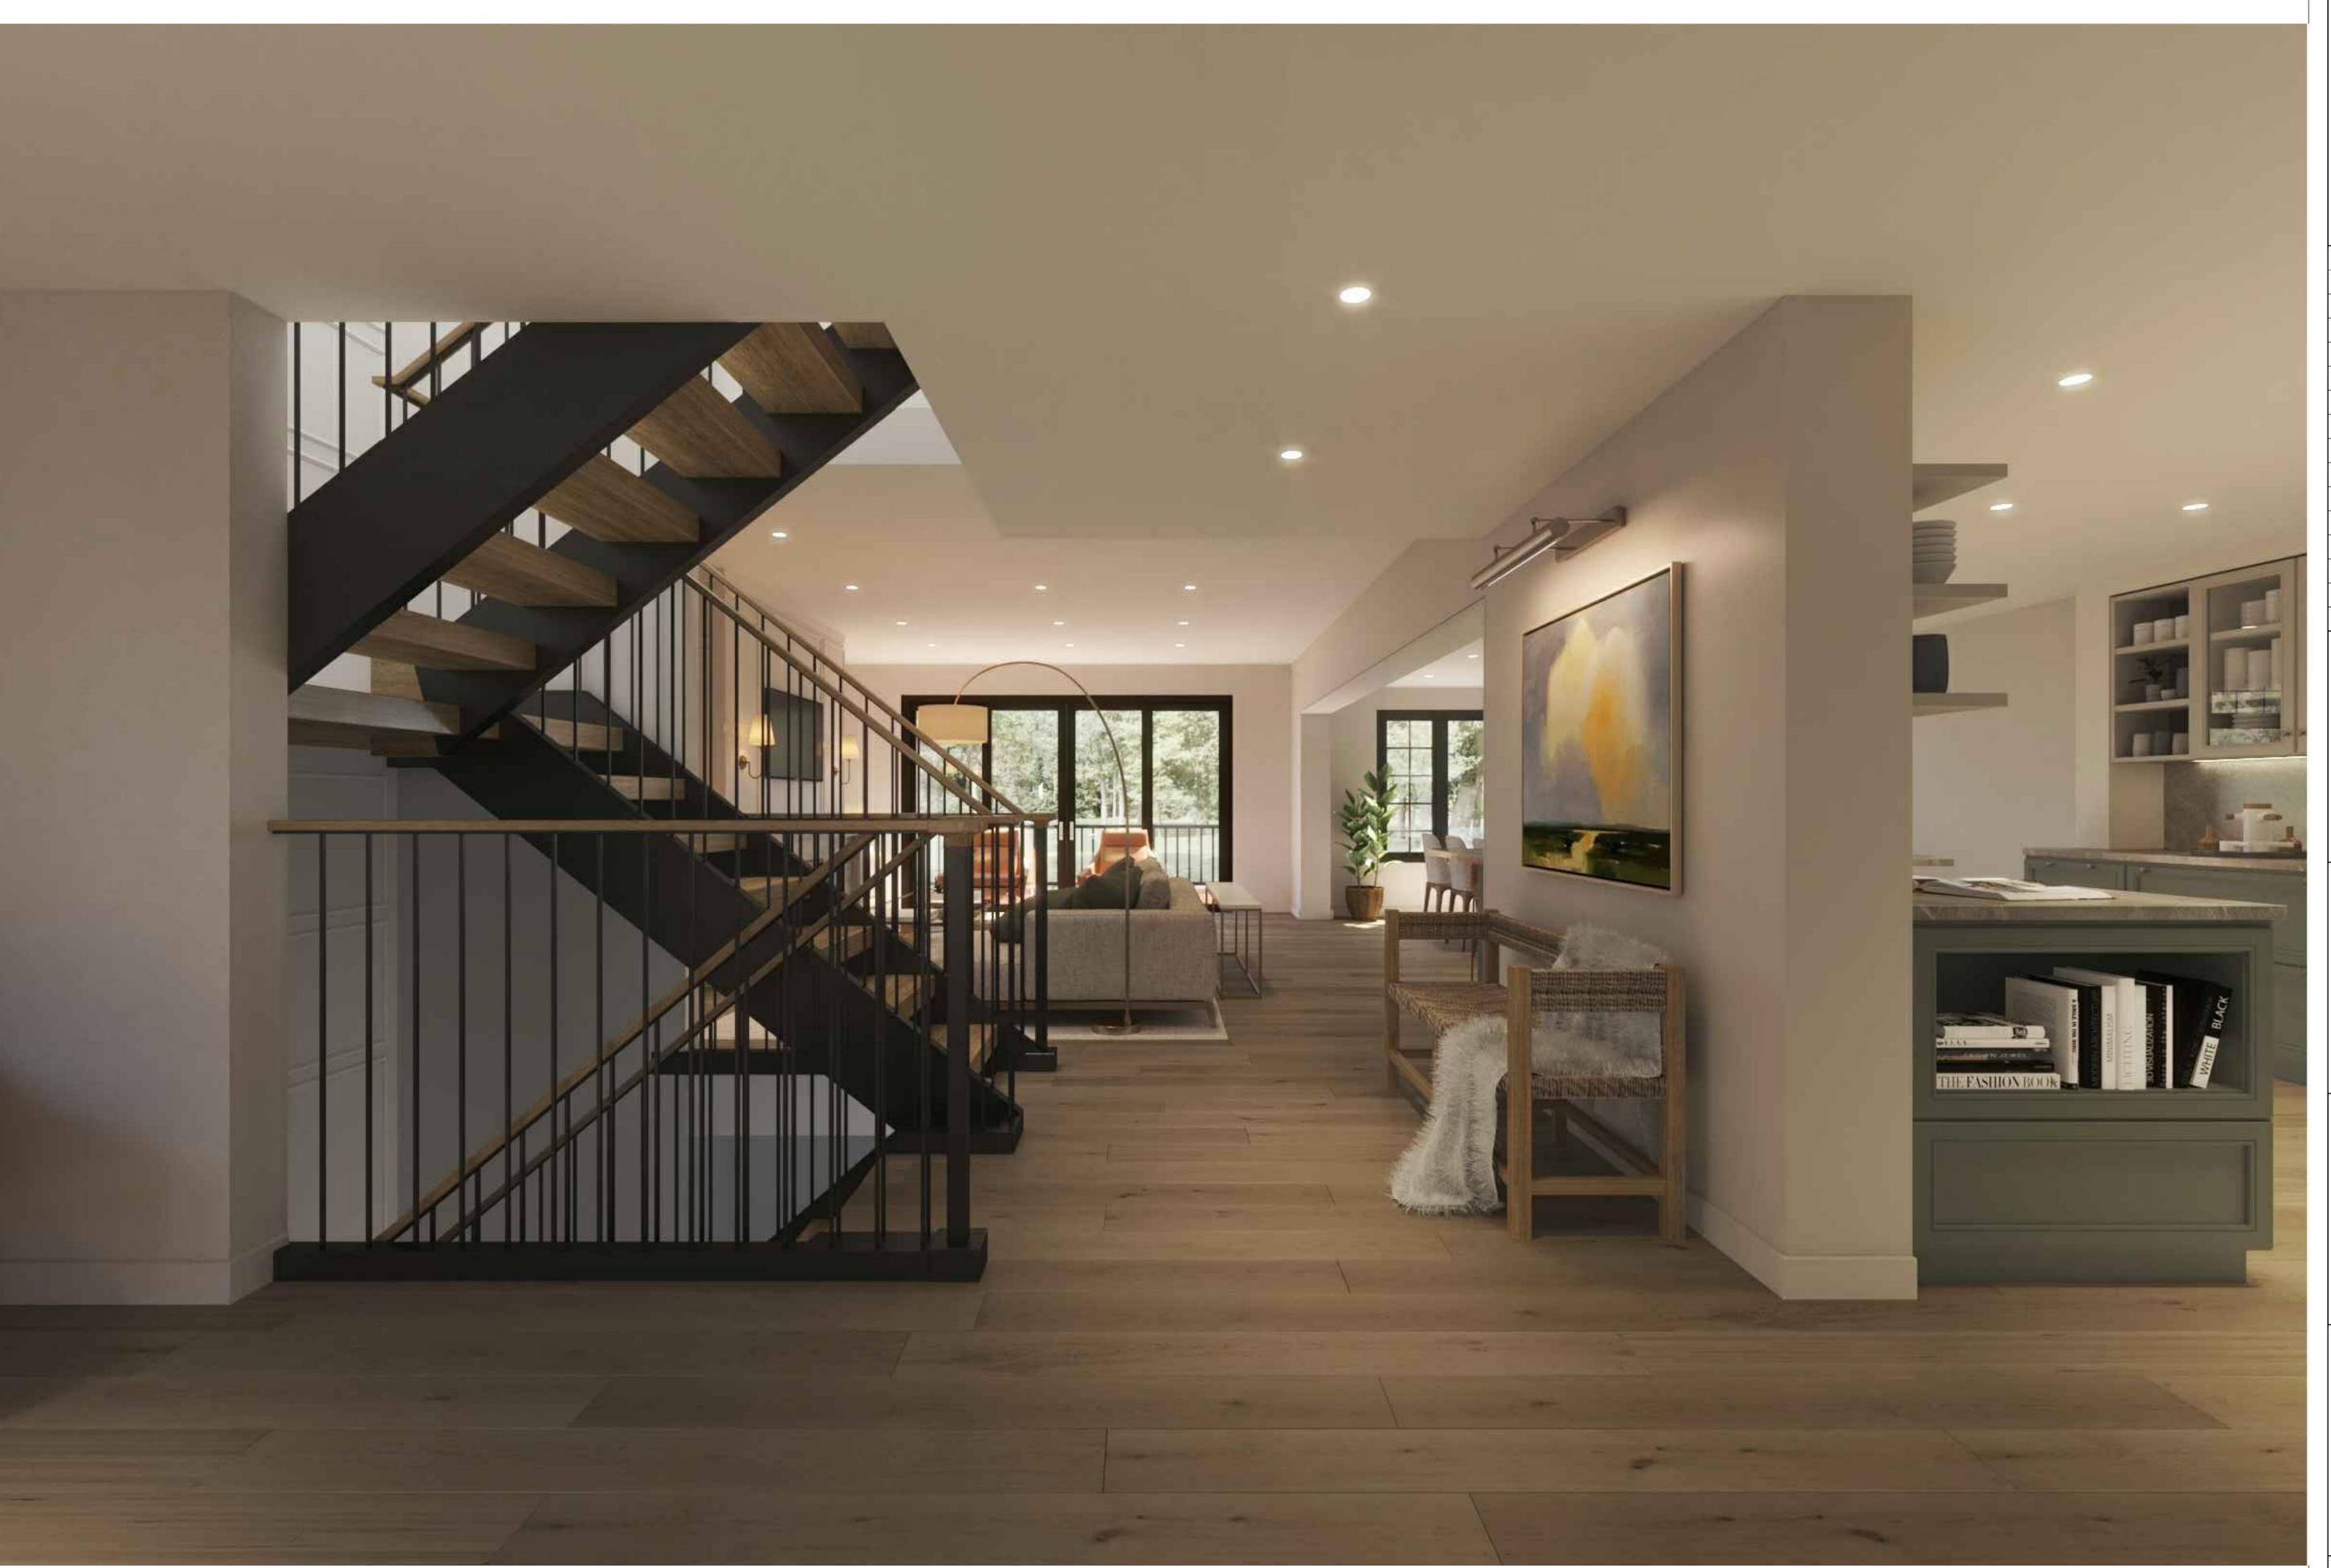
EXTERIOR RENDERING

Date	Project Number
11/29/2023	23-054
11/20/2020	20 004
Drawn by	Drawing Number
JTK/ AND/ KH	
Charled by	

JTK/ AND/ KH

Checked by
SMD/AND

Approved
SMD/AND





Issue:	Date:	Ву:
PRICING SET	09/11/23	SMD
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INTERIOR RENDERING

Date	Project Number
11/29/2023	23-054
Drawn by	Drawing Number
JTK/ AND/ KH	
Checked by	

AR-2 SMD/AND

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SMD/AND



Issue:	Date:	Ву:
PRICING SET	09/11/23	SMD
PRICING SET-VE REVISION	10/26/23	SMD

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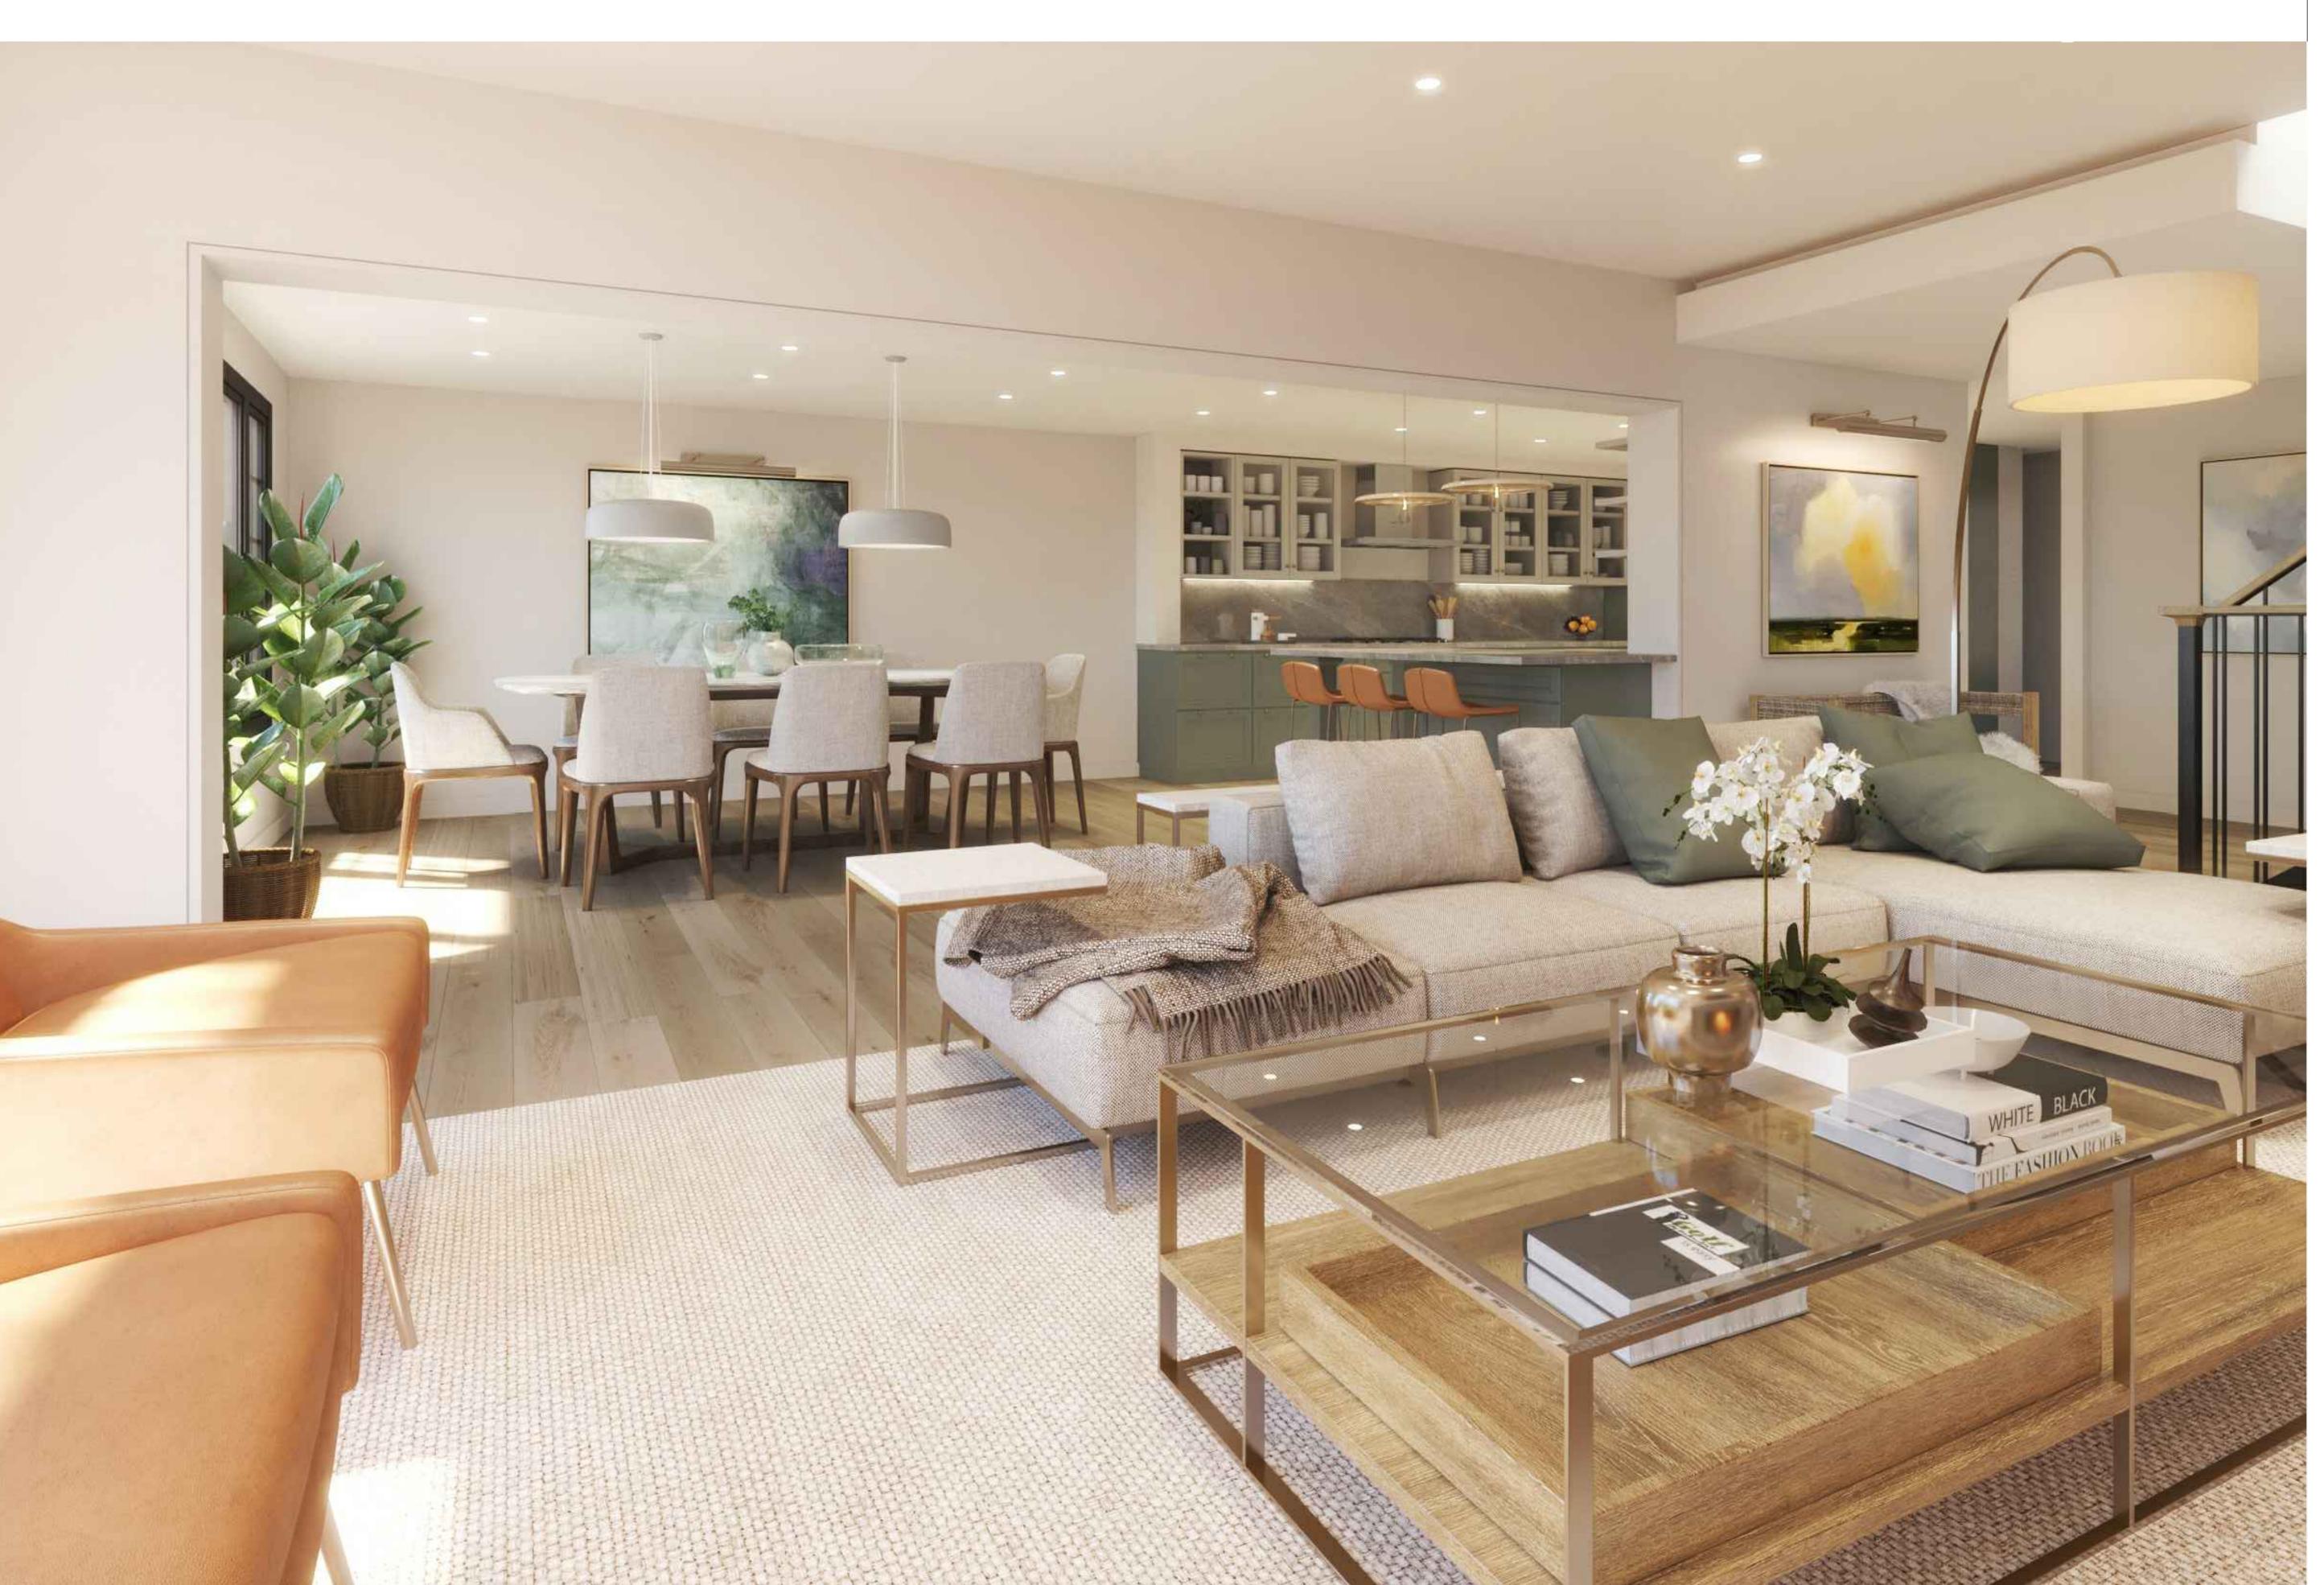
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INTERIOR RENDERING

Date 11/29/2023	Project Number 23-054
Drawn by JTK/ AND/ KH	Drawing Number
Checked by SMD/AND	AR-3
Approved SMD/AND	<i>/</i> (1 ()

RENDERING ROOM





Issue:	Date:	Ву:
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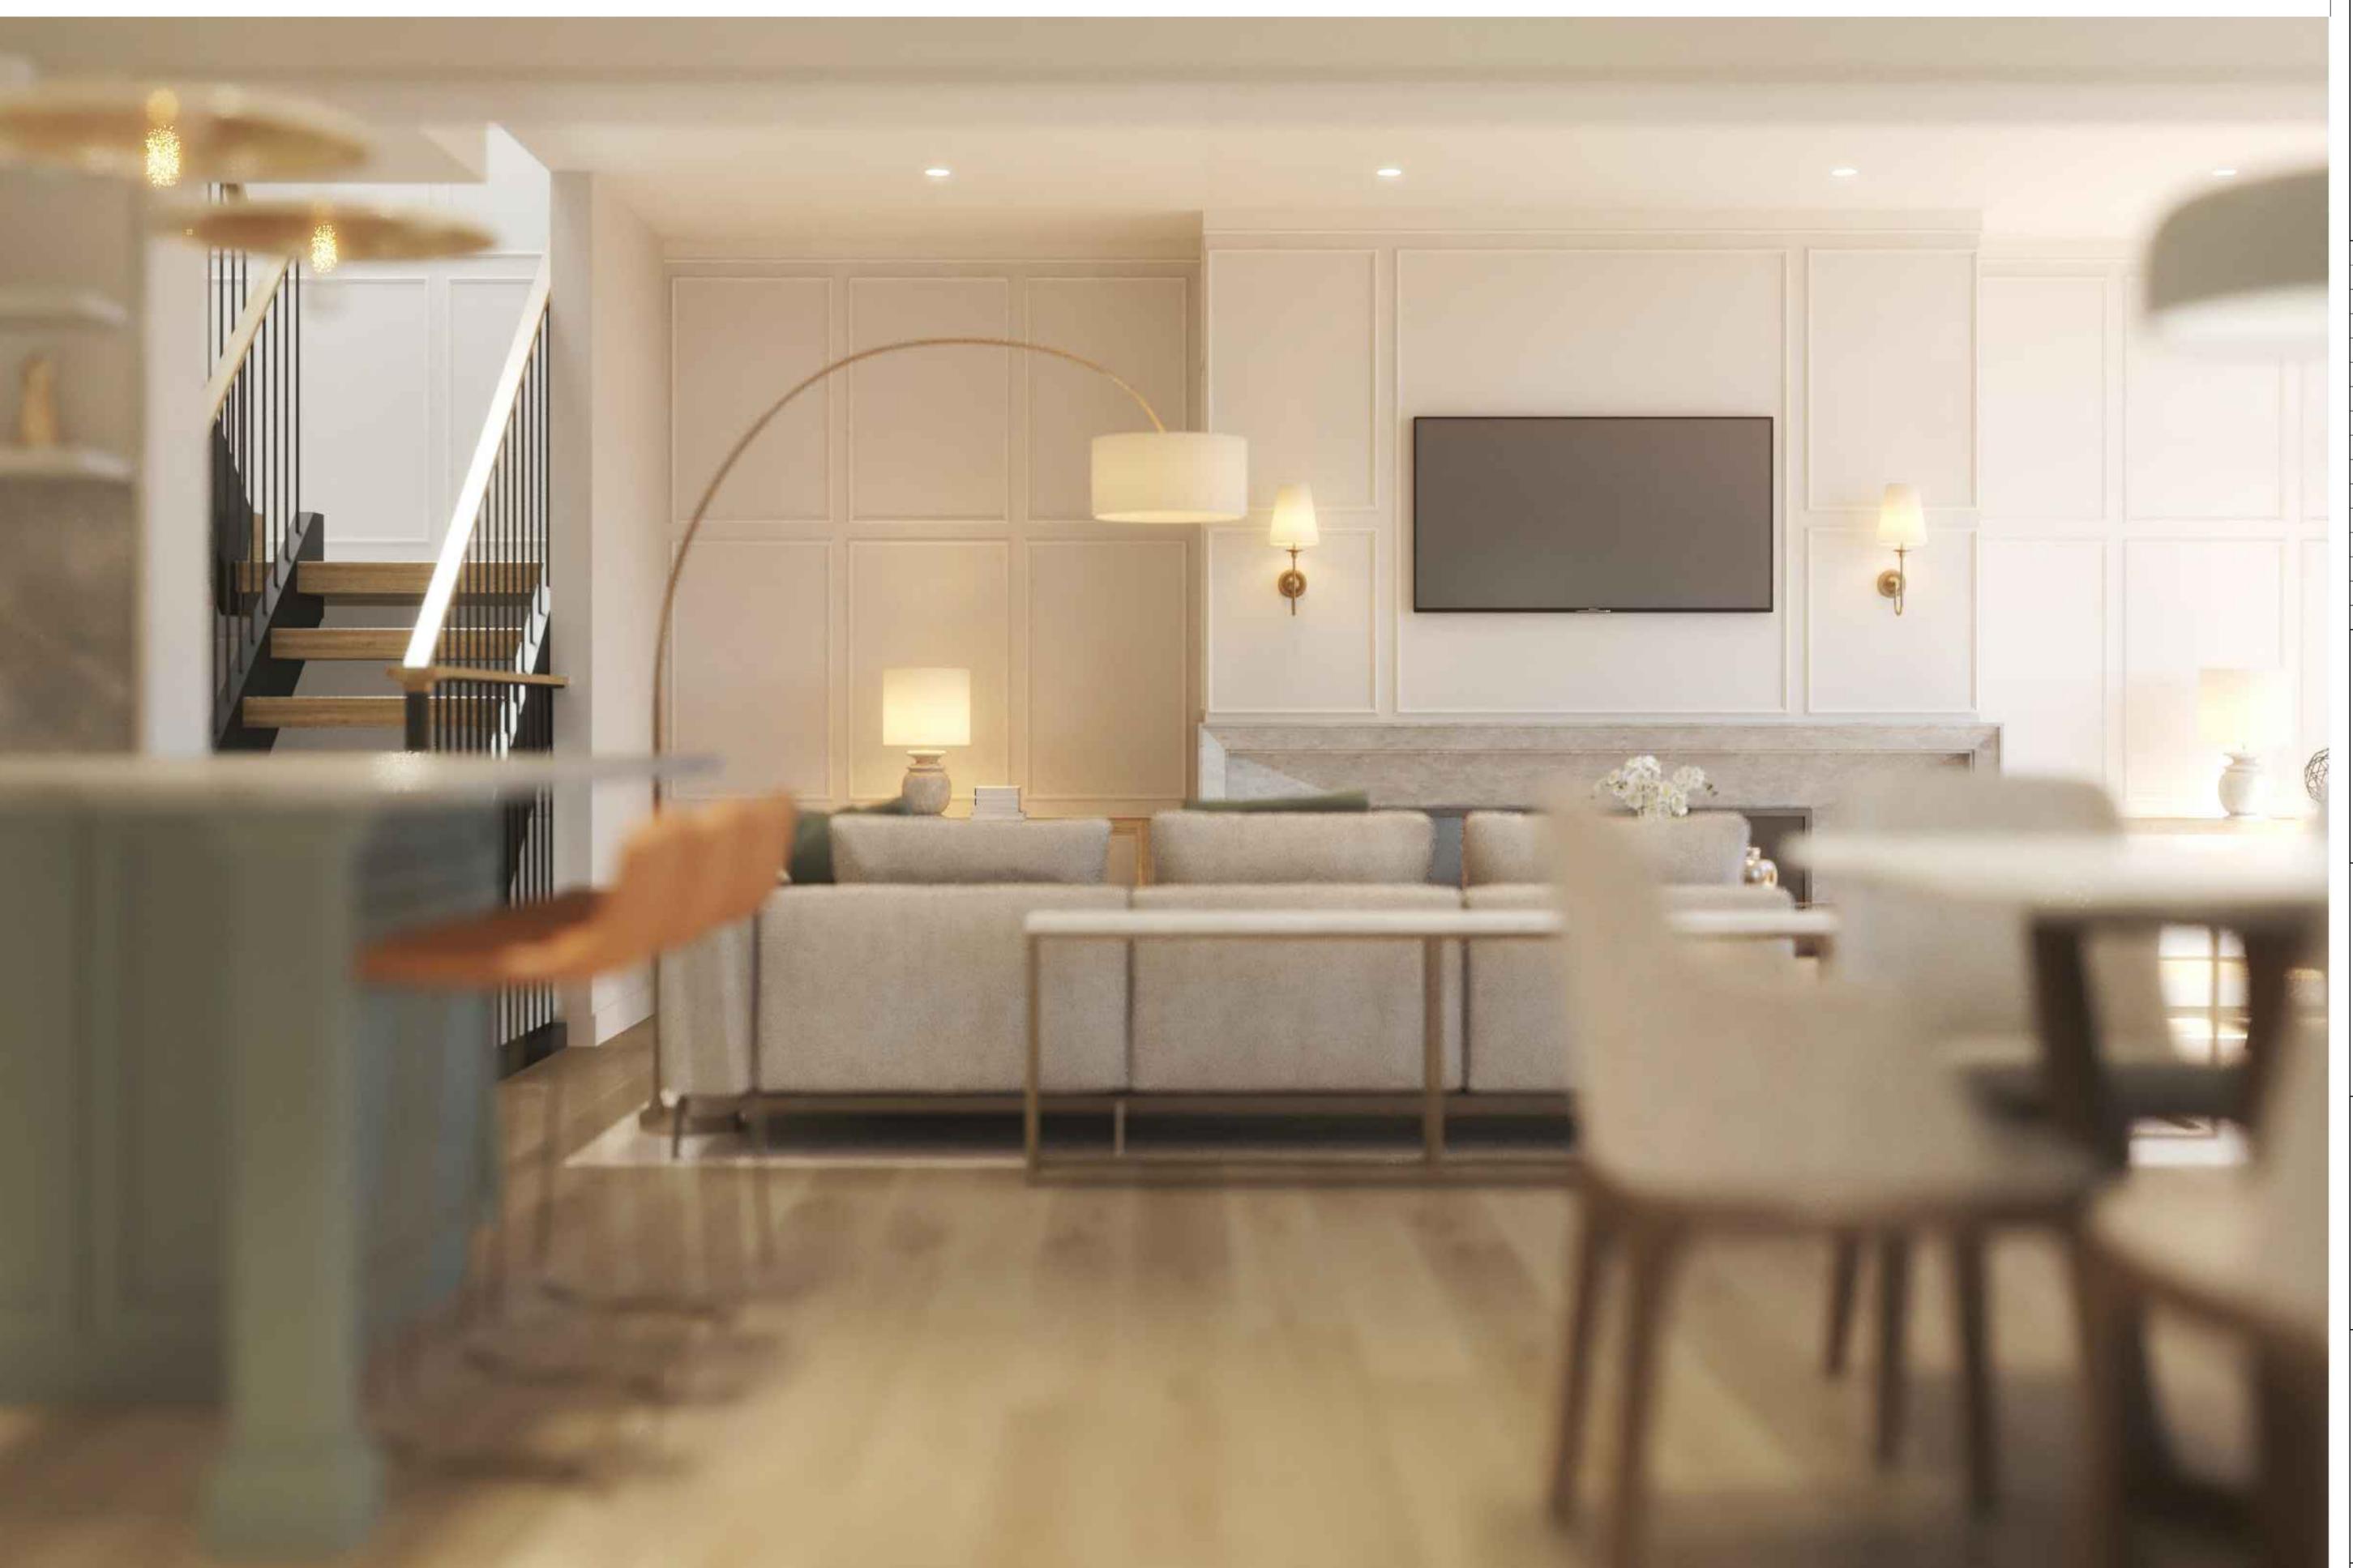
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INTERIOR RENDERING

Date	Project Number
11/29/2023	23-054
1.1,20,2020	20 00 .
Drawn by	Drawing Number
JTK/ AND/ KH	
OTTY AND/ INT	
Checked by	

AR-4 SMD/AND
Approved
SMD/AND

1 RENDERING ROOM
AR-4





Issue:	Date:	Ву:
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INTERIOR RENDERING

11/29/2023	Project Number 23-054
Drawn by	Drawing Number
JTK/ AND/ KH	
Checked by SMD/AND	AR-5
Approved	<i>/</i> (1 ()
SMD/AND	

RENDERING AREA



Issue:	Date:	Ву:
PRICING SET	09/11/23	SMD
DRICING SET VE REVISION	10/26/23	SMD

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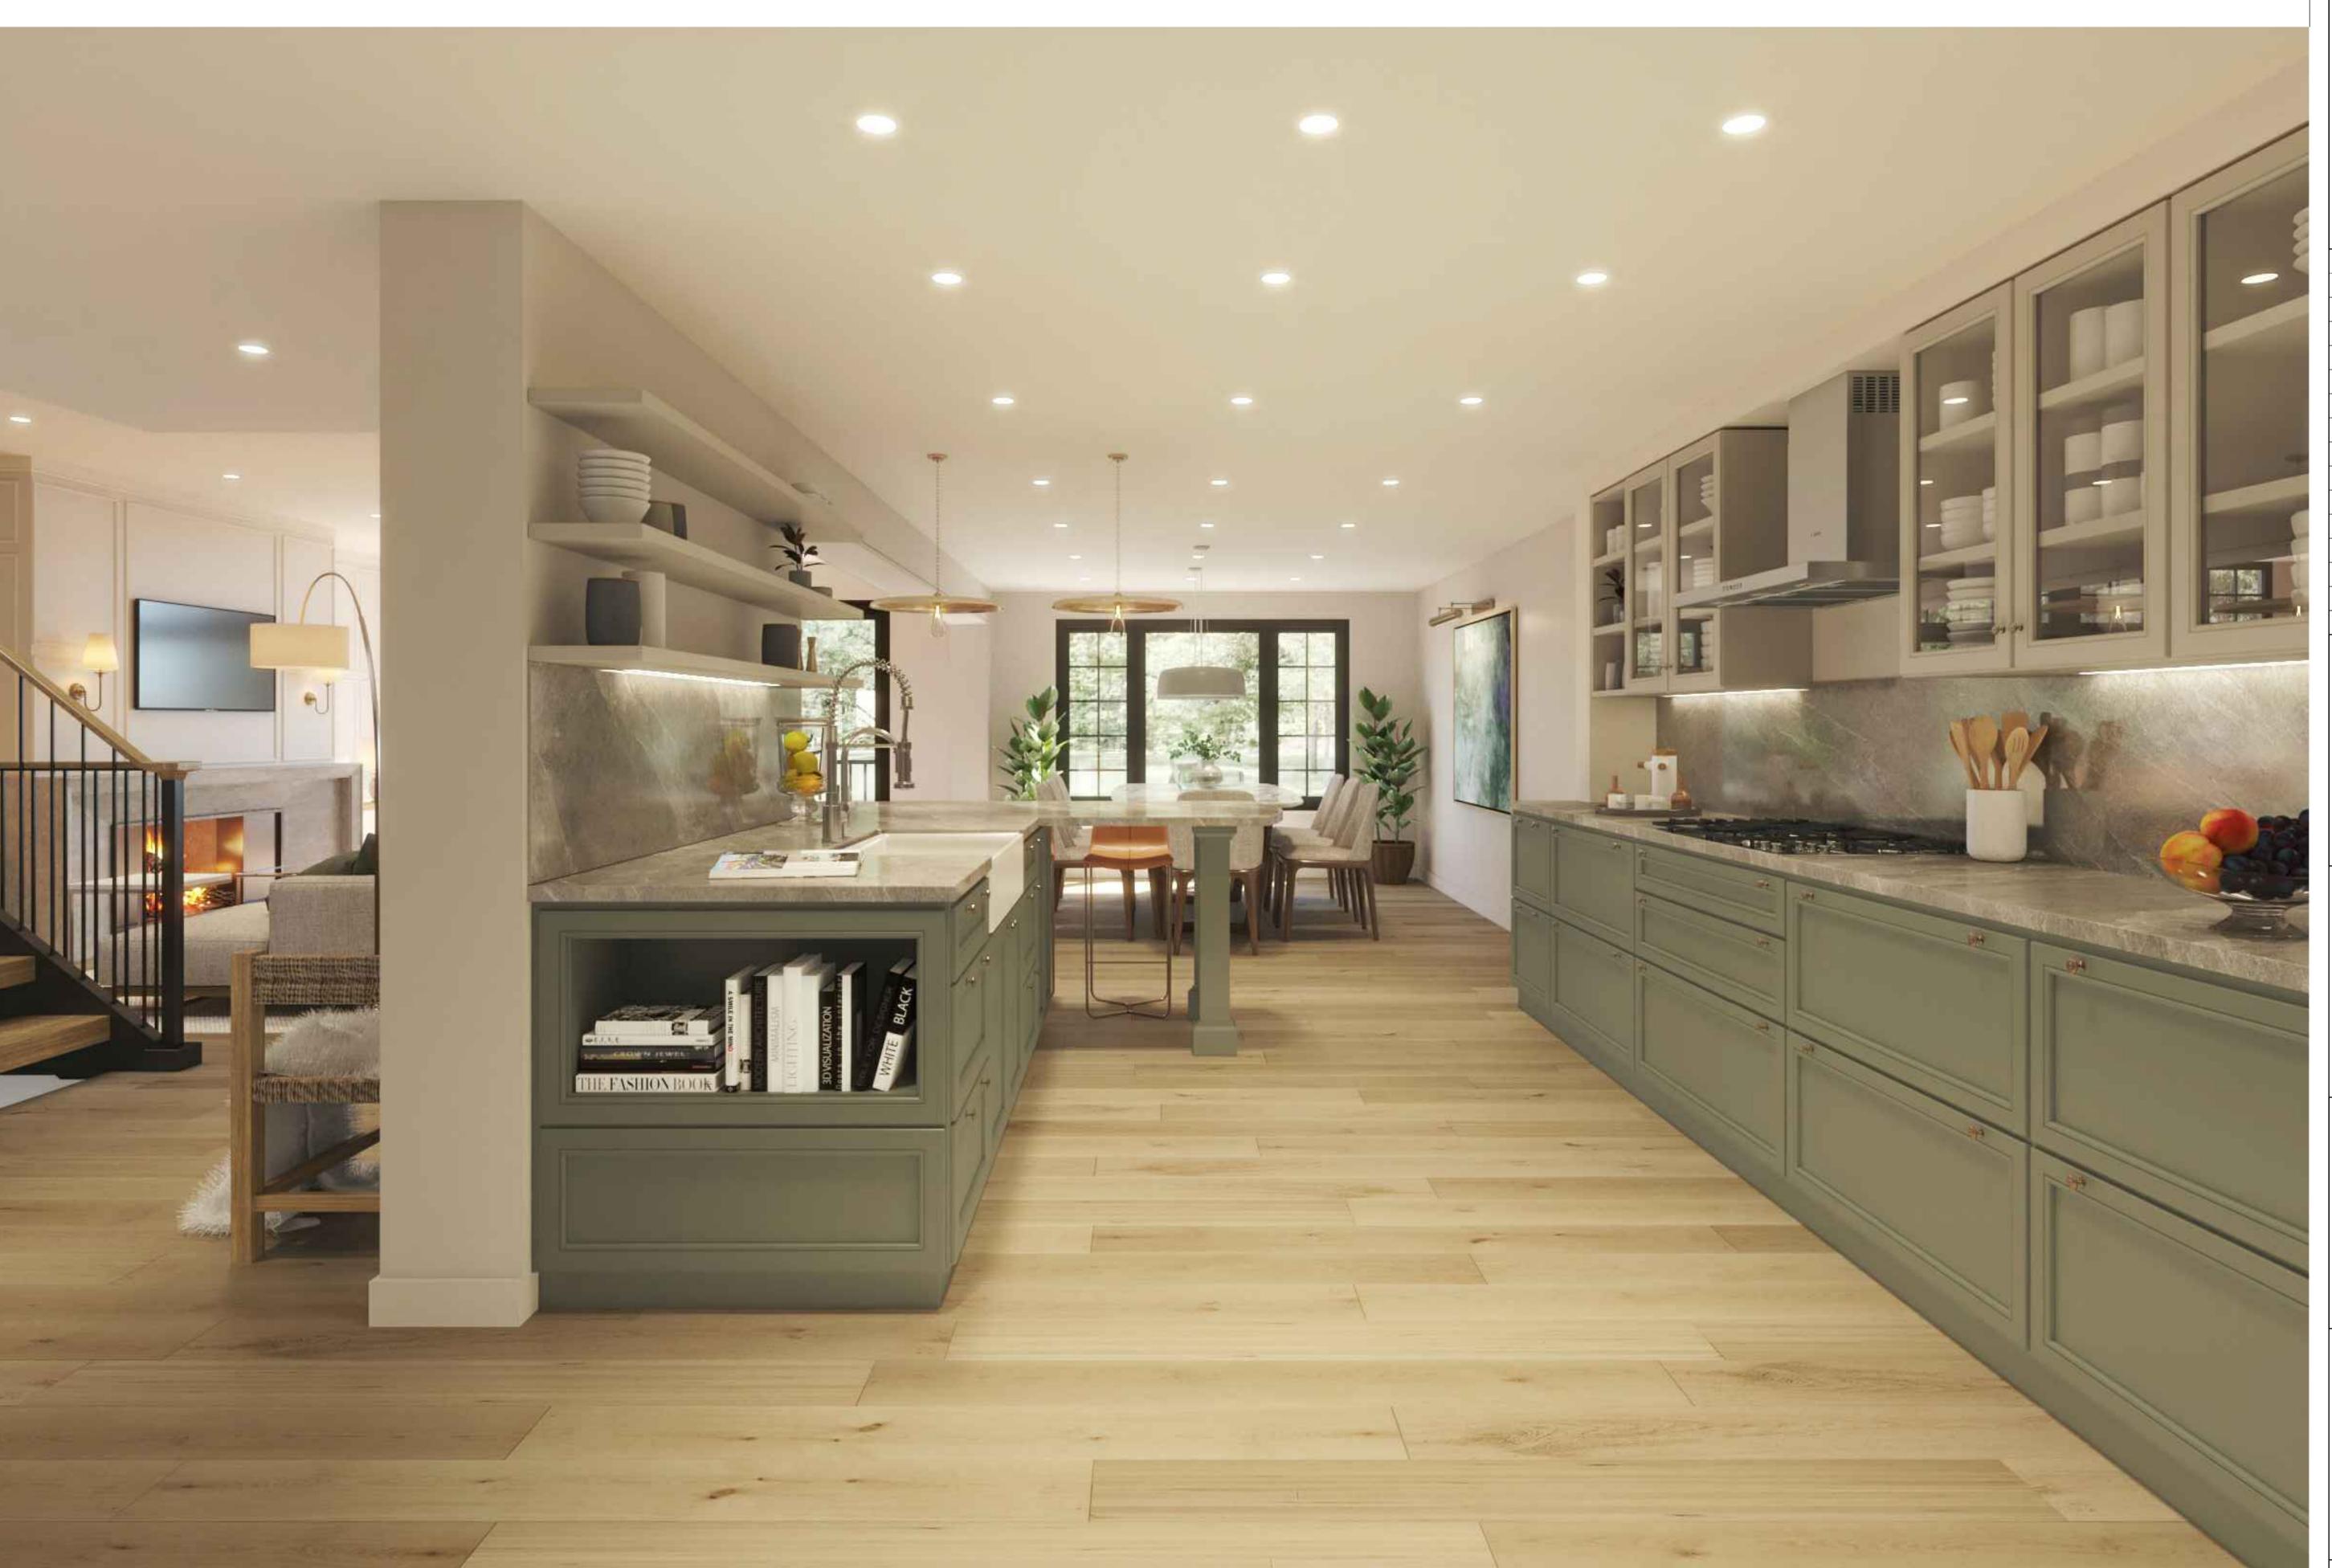
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INTERIOR RENDERING

Date 11/29/2023	Project Number 23-054
Drawn by JTK/ AND/ KH	Drawing Number
Checked by SMD/AND	AR-6
Approved SMD/AND	/ \\ \ \ \



Issue:	Date:	Ву:
PRICING SET	09/11/23	SMD
DRICING SET VE REVISION	10/26/23	SMD

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Date	Project Number
11/29/2023	23-054
Drawn by	Drawing Number
JTK/ AND/ KH	

Checked by
SMD/AND
Approved
SMD/AND AR-7



Issue:	Date:	Ву:
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INTERIOR RENDERING

Date 1.1 /00 /0002	Project Number 23-054
11/29/2023	23-054
Drawn by	Drawing Number
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Issue:	Date:	Ву:
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PRICING SET-VE REVISION	10/26/23	SMD

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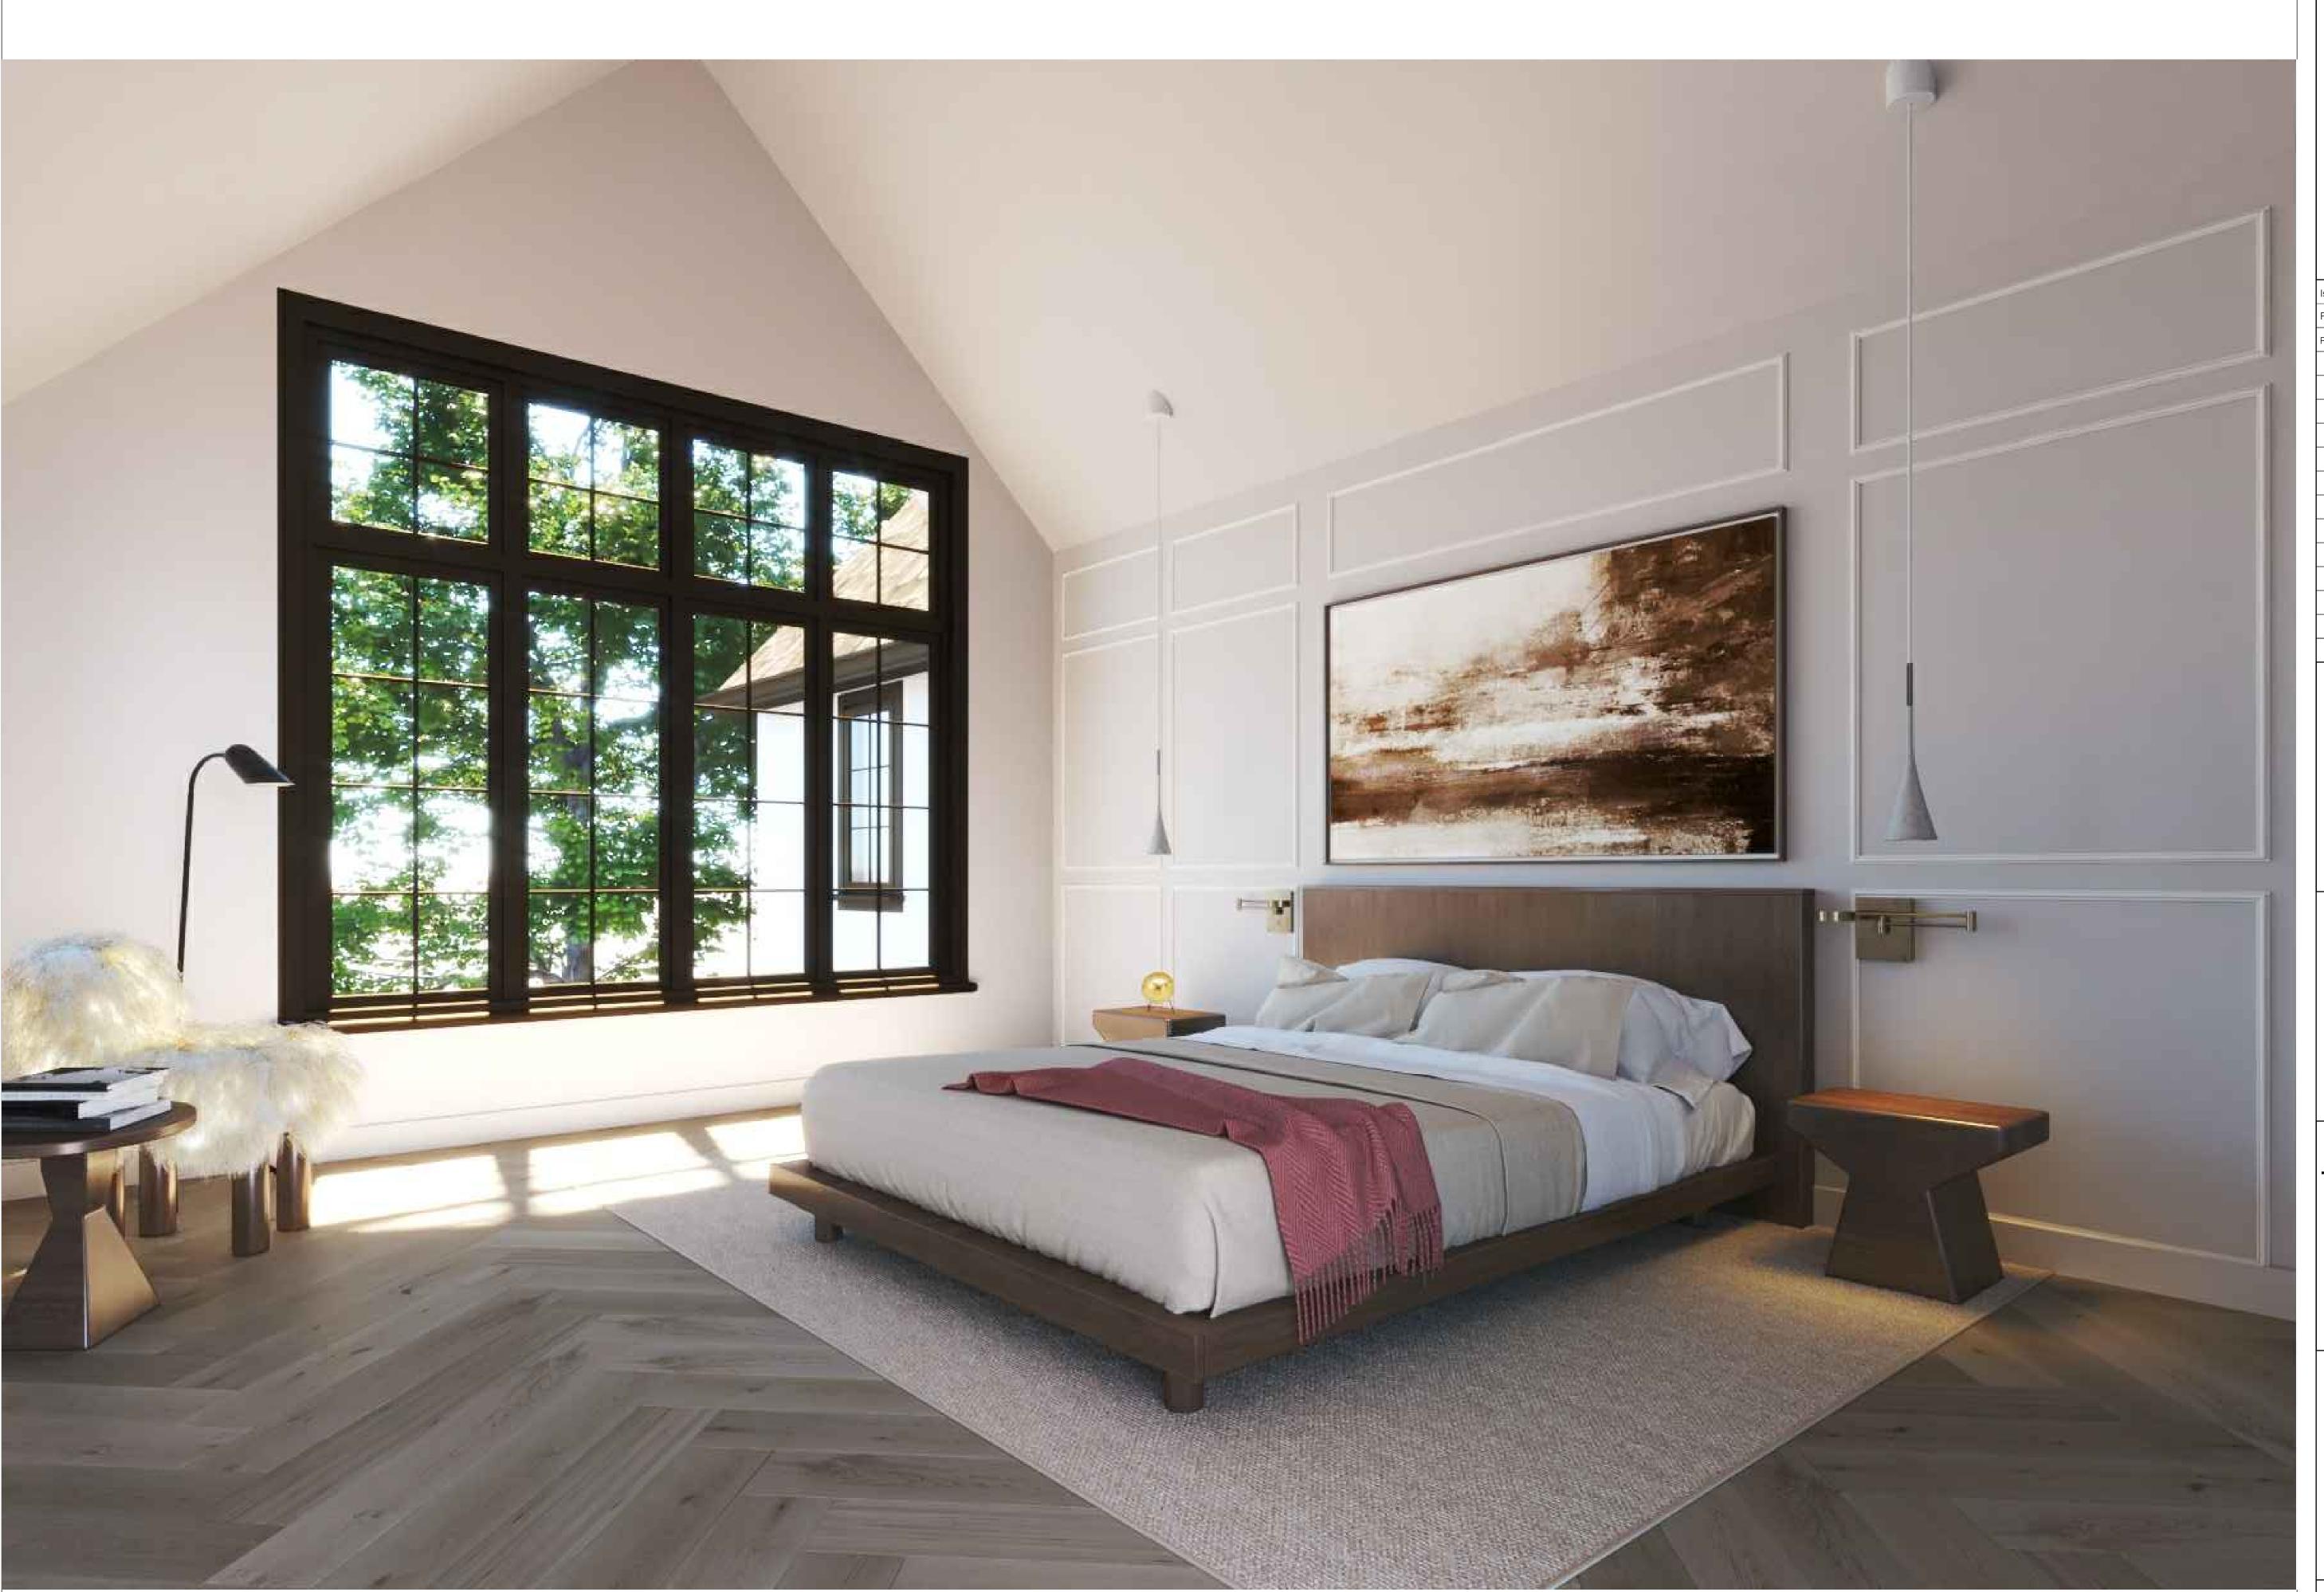
INTERIOR RENDERING

Date	Project Number
11/29/2023	23-054
Drawn by JTK/ AND/ KH	Drawing Number
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Checked by
SMD/AND

Approved
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DRICING SET VE REVISION	10/26/23	SMD

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INTERIOR RENDERING

Date 11/29/2023	Project Number 23-054
Drawn by JTK/ AND/ KH	Drawing Number

NASTER BEDROOM

JTK/ AND/ KH
Checked by
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Date	Project Number
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Drawn by	Drawing Number

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Checked by
SMD/AND
Approved
SMD/AND

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